

<u>20181758 – BL419 – Psychology – AHU-7 Humidifier Modifications</u> Addendum 1

November 18, 2025

General Notifications

Modifications described herein shall be incorporated into the project documents. All other work described in the project documents shall remain unchanged.

Acknowledge receipt of this Addendum by noting it on the Bid Form. Failure to do so may subject bidder to disqualification. This Addendum is a part of the contract documents.

Pre-Bid Meeting Minutes

The attached meeting minutes are a summary of the three pre-bid meetings held on the project.

Pre-Bid Sign-In Sheet. Attendance at a minimum of one of the pre-bid meetings is required for prime bidders.

Bidding Questions and Answers

The below questions have been submitted either electronically or asked during the pre-bid walkthrough.

Question 1: Is it acceptable to use the passenger elevator to move materials through the building?

Answer 1: Yes, but the use needs to be coordinated with the building user group and the elevator appropriately protected.

Question 2: What is the path to move materials into the building.

Answer 2: Through the north courtyard and the dock area of adjacent building just east of the Fee Lane Parking Garage.

Changes to the Drawings

Modify the attached drawings below as indicated in the clouded areas.

- 1. Sheet M102 Penthouse Mechanical Demolition Plan
- 2. Sheet M202 Penthouse Mechanical Plan
- 3. Sheet M501 Mechanical Details

Attachments

- 1. Pre-Bid Meeting Minutes
- 2. Pre-Bid Sign-In Sheet.
- 3. Sheet M102 Penthouse Mechanical Demolition Plan



- 4. Sheet M202 Penthouse Mechanical Plan
- 5. Sheet M501 Mechanical Details

End of ADDENDUM 1



Meeting Date: 11-7-2025

Minutes Issued: 11-18-2025 (Addendum 1)

Prebid Meeting - Minutes

BL419 Psychology – AHU-7 Humidifier Modifications Indiana University Bloomington IU 20181758

1. Introductions

- A. Owner:
 - 1. The Trustees of Indiana University.
- B. Capital Projects
 - 1. Darby Simpson, IU Team Lead.
 - 2. Ryan McComas, IU Mechanical
 - 3. Karl Parker, IU Electrical
 - 4. Matt Harms, IU Construction Administrator
- C. Consultant ATP Engineering
 - 1. Doug Bradley Mechanical (dbradley@atp-eng.com)
 - 2. Dave Shuck Electrical (dshuck@atp-eng.com)
- 2. Project Description
 - A. The project consists of work in the Psychology Building.
 - 1. Remove existing steam to steam humidifiers in the 5th floor mechanical room serving AHU-7 and serving ductwork supplying air to the 4th floor. Remove existing duct mounted humidifier and patch ductwork. Existing AHU mounted humidifier shall remain and be re-fed with campus steam. Provide new duct mounted reheat coil and duct mounted humidifier served with campus steam as shown on the Construction Documents. Modify ductwork in 4th floor LAR spaces as shown in the Contract Documents. Work is anticipated to be performed between August 1, 2026 and September 1, 2026.
- 3. Project Schedule
 - A. Project completion date shall be no later than September 1, 2026.
- 4. Project Website:
 - A. Indiana University will utilize E-builder for document management.
 - B. Contractors must have appropriate hardware/software to create and read PDF documents.
- 5. Protocol for Questions:
 - A. Questions shall be submitted in writing via e-mail to Consultant, dbradley@atp-eng.com. The last day for questions is noon on November 17, 2025.
- 6. Bids will be accepted at or before 2:00 P.M. Eastern Time on November 25, 2025



- A. Submit bids electronically via www.iuplanroom.com. Refer to notice to bidders.
- B. Public Bid opening; Bids read aloud. Refer to notice to bidders for virtual bid opening information.
- C. Late Bids will not be accepted.
- 7. Documents are available from Eastern Engineering. Contact Eastern for deposit and purchase information.
- 8. Alternates none
- 9. Parking
 - A. There will be limited on-site parking. Contractor parking is in the Green lot.
- 10. Concurrent Projects
 - A. None.
- 11. Dumpster Location
 - A. No dumpster, contractor shall haul trash away daily.
- 12. The project spaces were toured by the contractors in attendance.




11-7-2025

Prebid Meeting - Sign-In Sheet

BL419 Psychology – AHU-7 Humidifier Modifications Indiana University Bloomington IU 20181758

Company	Name	Phone Number	Email		
HFI	COLIN HINDMAN	(812) 339 - 25 79	Chindmanaharrell-fish.com		
SR MECHANICAL	JAREN BUTLER	812 675 9803	JBUTLER @ SRMECHANICALLLCOM		
IRISH	Jeremey Boner	317-294-9781	Iboner @irishmechairal Services.com		
TRISH	Tom	317-306-1357	THalledirishmechanical Services.com		
Commercial Service	Jeff RothAAR	812-929-9048	1 Fothwar @ commercial Service. com		
- N. W. C. S. Carlo		812-856-5893 (765) 341-9006	darbsimp elu. Edu ramccoma@iu.edu		
HEFLIN	DAVID DEPIERRE	812825 1600	ddepierre eheflinind, cou		

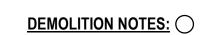

- 1. REMOVE EXISTING STEAM TO STEAM HUMIDIFIER, CONTROLS, ETC.
- 2. REMOVE HOUSE LPS, SECONDARY LPS, LPR, DRAIN, AND DOMESTIC COLD WATER TO HUMIDIFIER.
- 3. REMOVE PIPING TO POINT SHOWN, TYPICAL.
- 4. REMOVE NPW BACK TO THIS POINT AND PREPARE FOR CONNECTION TO HOSE BIBB.
- 5. REMOVE BACK TO VALVE AND PREPARE FOR
- CONNECTION TO NEW.
- 6. REMOVE EXISTING DUCT MOUNTED HUMIDIFIER AND PATCH DUCTWORK AIRTIGHT. REMOVE DRAIN FROM HUMIDIFIER AND DRAIN DOWNSTREAM OF THE HUMIDIFIER.
- 7. REMOVE SECONDARY LPS AND DRAIN FROM HUMIDIFIER IN THE AIR HANDLING UNIT. THE HUMIDIFIER SHALL REMAIN IN PLACE. PREPARE FOR CONNECTION TO NEW PIPING.
- 8. REMOVE SUPPLY DUCTWORK TO ALLOW NEW HEATING COIL AND HUMIDIFIER TO BE INSTALLED. REFER TO M202 FOR NEW WORK.
- PRIOR TO DEMOLITION, PERFORM TEST AND BALANCE TO MEASURE THE DUCT CFM AND STATIC PRESSURE. RECORD VALUE AND SUBMIT TO THE ENGINEER.
 REMOVE EXISTING SUPPLY GRILLE AND SALVAGE FOR RE-INSTALLATION.


BUB BUB Che Che Do DAB Dot PENTHOUSE MECHANICAL DEMOLITION PLAN BUILDING

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Drawing Number:

M102

1 PENTHOUSE MECHANICAL DEMOLITION PLAN 1/4" = 1'-0"

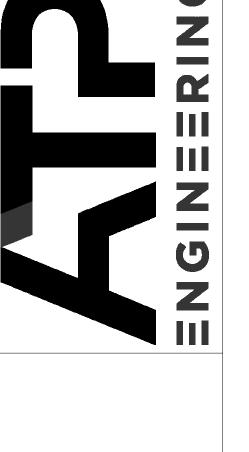


Drawn By:	BJB		Cilecked by:	UAB	20181758 - BL419 - PSYCHOLOGY BUILDING - AHU-7 Project Status:	Documents	Date: 10 30 2025	0.00.00
		Number	1					
<u>.</u>		Date	1.18.2025					
Revisions		Description	11.18.2025 Addendum 1					

North North

M202

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HUMIDIFIER AND REHEAT COIL ELEVATION

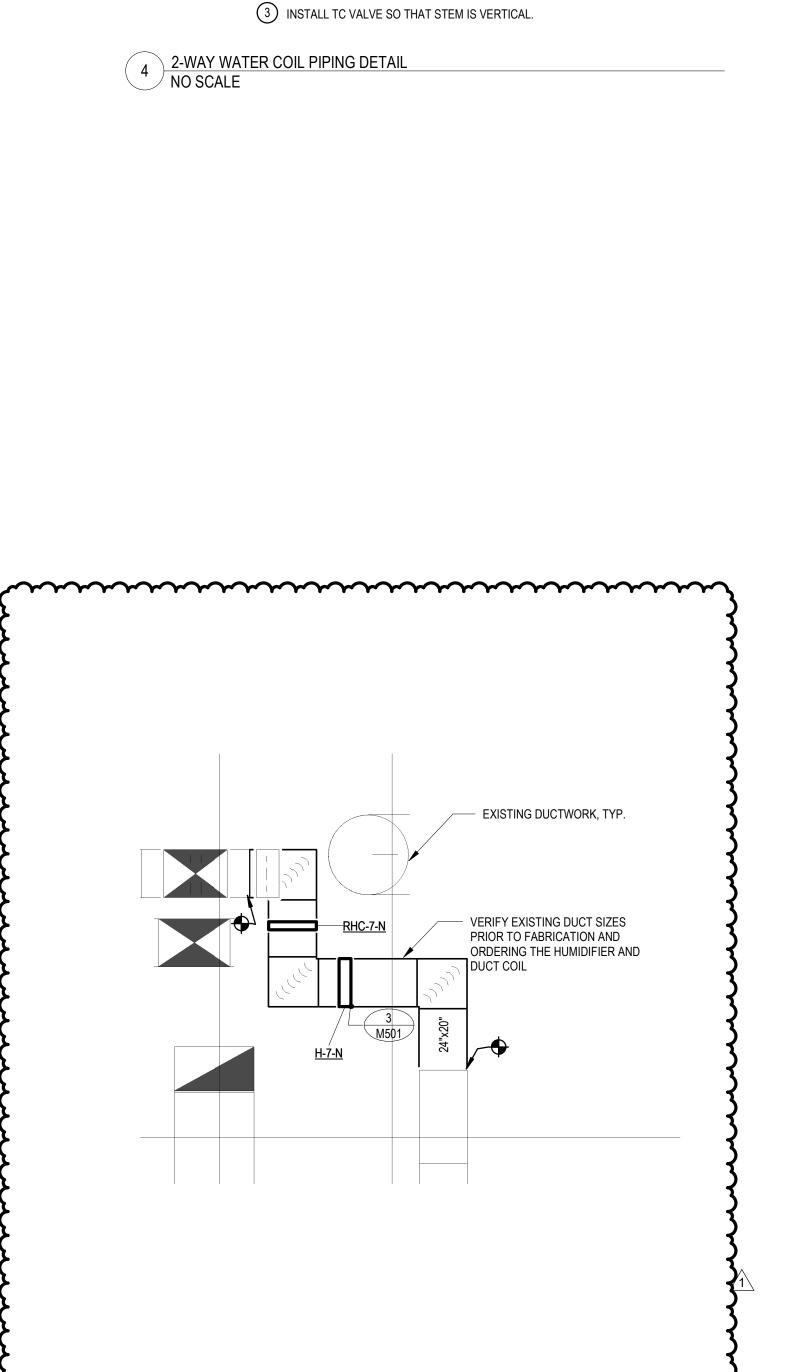3 2-WAY TC VALVE

PRESSURE & TEMPERATURE

COIL

NOTES:

MANUAL AIR VENT

PLUG, TYP

UNION, TYP

2 3/4" DRAIN W/ HOSE CONNECTION AND CAP

2 INSTALL AT LOWEST POINT IN PIPING.


PROVIDE BUTTERFLY VALVES IN LIEU OF BALL VALVES WHEN PIPE SIZES ARE ABOVE 2", TYP.


CALIBRATED BALANCING VALVE


SUPPLY

STRAINER W/ BLOWDOWN AND CAP

- BALL VALVE, TYP 1

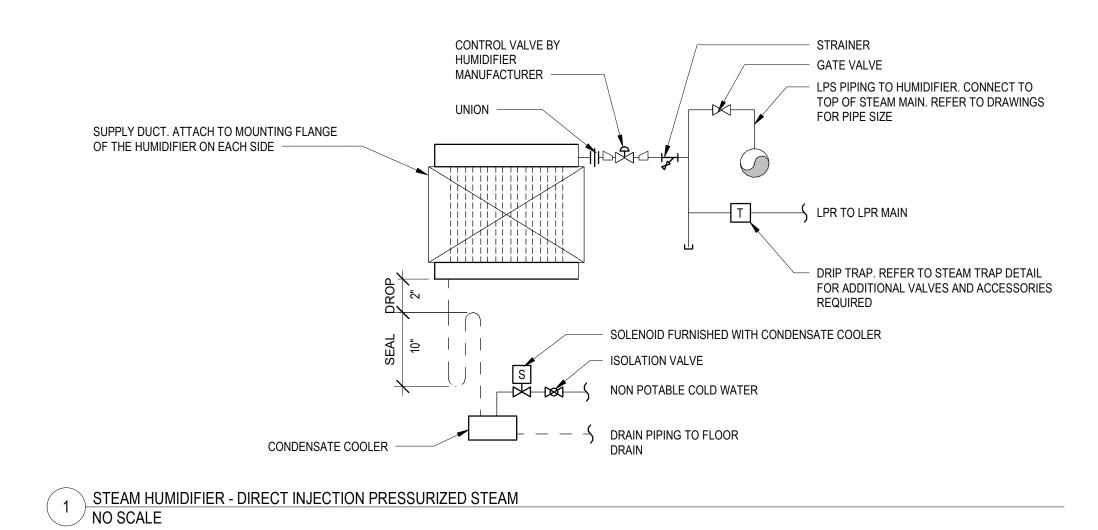

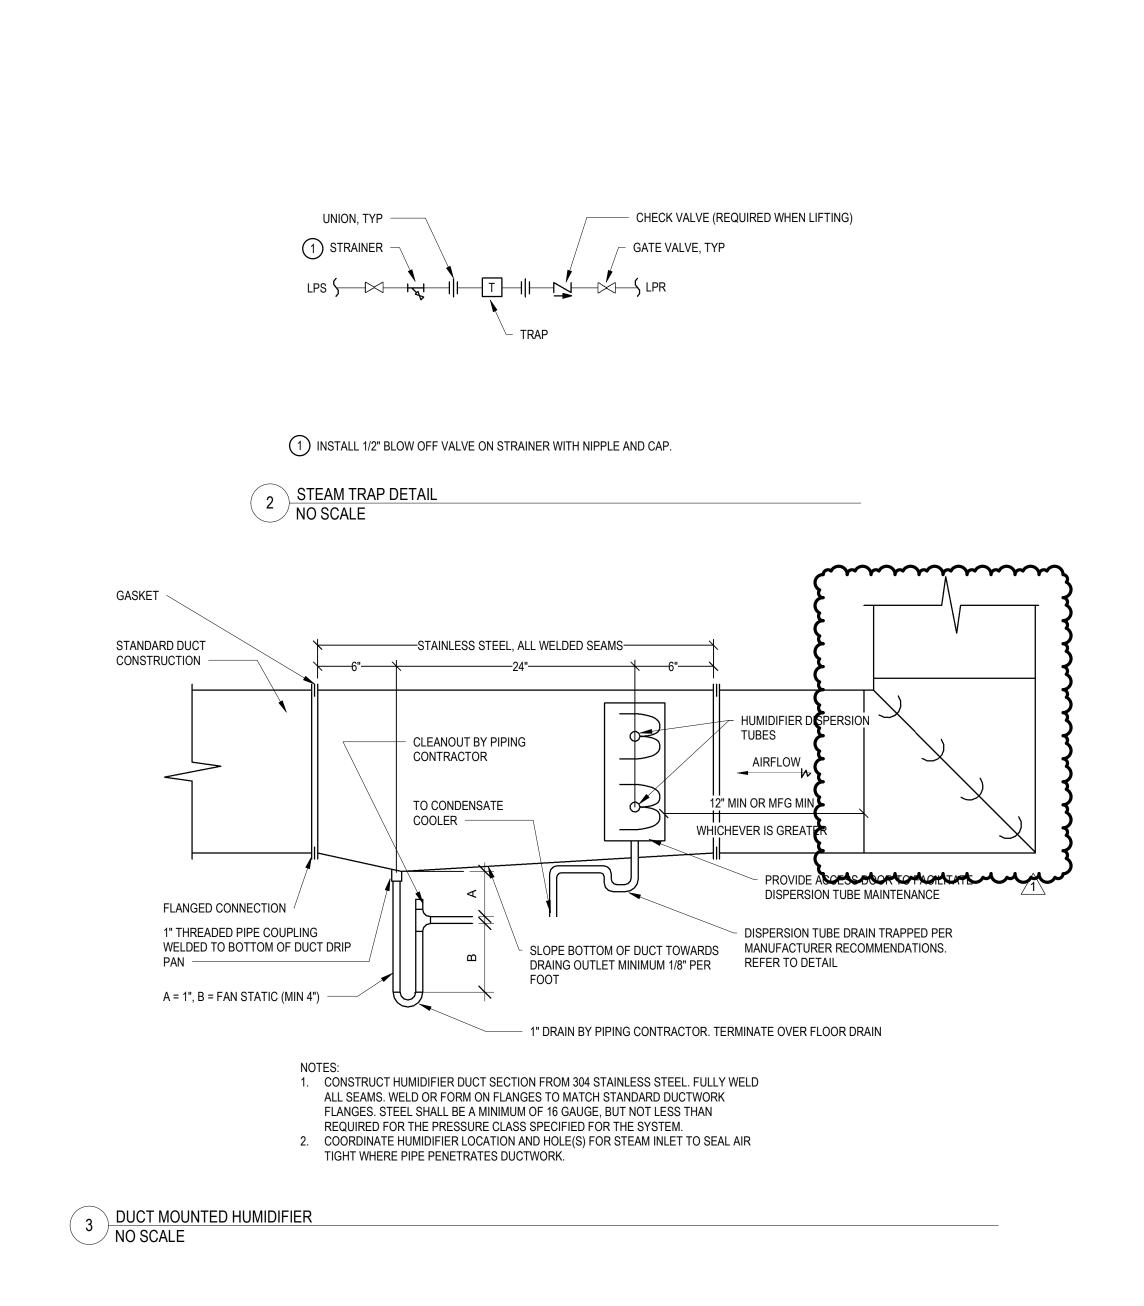

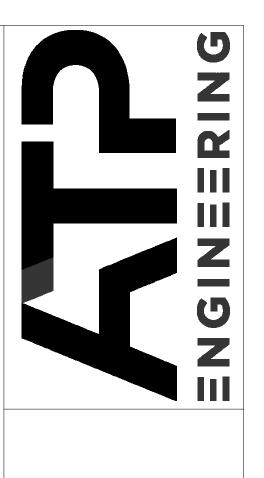

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DETAILS

BUB BUB Che DAB DO Dat