

Addendum 2

Owner Information	INDIANA UNIVERSITY
Contractor Information	N/A

DATE	01/23/2026
PROJECT NAME	BL572 – Intercollegiate Athletics Gymnasium – Replace Chiller, Heating Systems and Controls
INTROBA PROJECT #	2035.0013084
IU PROJECT #	20240613
DISTRIBUTION	Owner
ADDENDUM CONSIST OF	(1) 8.5 x 11 PAGES & (9) 30 x 42 PAGES

The following additions, revisions, and modifications are part of the contract documents, which shall be amended accordingly. Acknowledge receipt of addenda on the bid form. Failure to acknowledge receipt of this addendum may result in the rejection of your offer.

GENERAL

1. Bidder Questions & Answers:
 - a. List of bidder questions and provided answers is included in Addendum 2 documentation.

SPECIFICATIONS

1. Table of Contents
 - a. Removed DIVISION 03 CONCRETE specification reference.
2. Notice to Bidders
 - a. Updated bid time and date as follows:
 - i. 2:00 P.M. Eastern Time, February 5th, 2026.

DRAWINGS

GENERAL

1. COVER SHEET
 - a. Added S-101 "STRUCTURAL PLAN BL572 LEVEL 2 BASE BID" sheet to drawing set after Sheet A-102.

ARCHITECTURAL

2. D-101 – ARCHITECTURAL DEMOLITION PLAN, LEVEL 01 ALTERNATE BID
 - a. Revised Demolition Note D7.
 - b. Revised Demolition Note locations as indicated.
3. A-101 – ARCHITECTURAL FLOOR PLAN, LEVEL 01 ALTERNATE BID
 - a. Revised Floor Plan Note 3.

STRUCTURAL

1. S-101 – STRUCTURAL PLAN BL572 LEVEL 2 BASE BID
 - a. Added in its entirety.

PLUMBING

1. PD-200 – PLUMBING DEMOLITION PLAN BL571 LEVEL 1
 - a. Modified base vs. alternate bid language
2. PD-201 – PLUMBING DEMOLITION PLAN BL572 LEVEL 1 UNDERFLOOR
 - a. Modified drawing reference bid language
3. PD-202 – PLUMBING DEMOLITION PLAN BL572 LEVEL 1 & 2
 - a. Modified base vs. alternate bid language
4. P-201 – PLUMBING PLAN BL572 LEVEL 1 UNDERFLOOR
 - a. Reissued in its entirety.
5. P-202 – PLUMBING PLAN BL572 LEVEL 1 & 2
 - a. Reissued in its entirety.
6. P-600 – PLUMBING DETAILS & SCHEDULES
 - a. Water Heater Detail. Modified base vs. alternate bid language.

SIGNATURE Christopher Hawk




Bidder Questions & Answers (Addendum 2)

Project Name	BL572 – Intercollegiate Athletics Gymnasium – Replace Chiller, Heating Systems and Controls IU Project #20240613
By	Christopher Hawk & Samuel Hubbe

Refer to the below list of questions submitted by bidders and answers provided by engineer and owner as of January 23rd, 2026.

1. In the existing shower room, the ceiling calls to add channel directly to the bar joists and 2 layers of dry wall fastened to it. The drawings call for existing mechanicals and duct to remain. However, the hydronics and duct run just below the joists (photos attached). How would you like us to handle this on the bid?
 - a) Revised note 3 on Sheet A101: "1-HOUR FLOOR CEILING ASSEMBLY, THIS ROOM. PROVIDE A SUSPENDED GYPSUM BOARD CEILING SYSTEM W/(2) LAYERS OF 5/8" TYPE 'X'. CEILING HEIGHT TO BE AS HIGH AS PRACTICALLY POSSIBLE. ADD 6" BATT INSULATION ABOVE NEW CEILING." Refer to Addendum 2.
2. Rooms 005G and 001B both call for partial ceiling removal. Would it be acceptable to remove the ceiling completely and replace with either tile ceiling or drywall. The quotes to patch the plaster are high. I think I could replace the whole ceiling for half the cost of patching.
 - a) Contractor option will be to remove plaster ceiling complete and provide new suspended, (1) layer 5/8" gypsum board ceiling system, matching existing ceiling height, paint, at these rooms. Noted on D101, refer to Addendum 2.
3. Are we patching the block wall with the shower heads or can we just remove the shower trim and furr the wall out?
 - a) The walls where shower heads are being removed are to be furred out, reference Wall Type 1 on sheet A-101.
4. In the existing shower room, the ceiling calls to add channel directly to the bar joists and 2 layers of dry wall fastened to it. The drawings call for existing mechanicals and duct to remain. However, the hydronics and duct run just below the joists (photos attached). How would you like us to handle this on the bid?

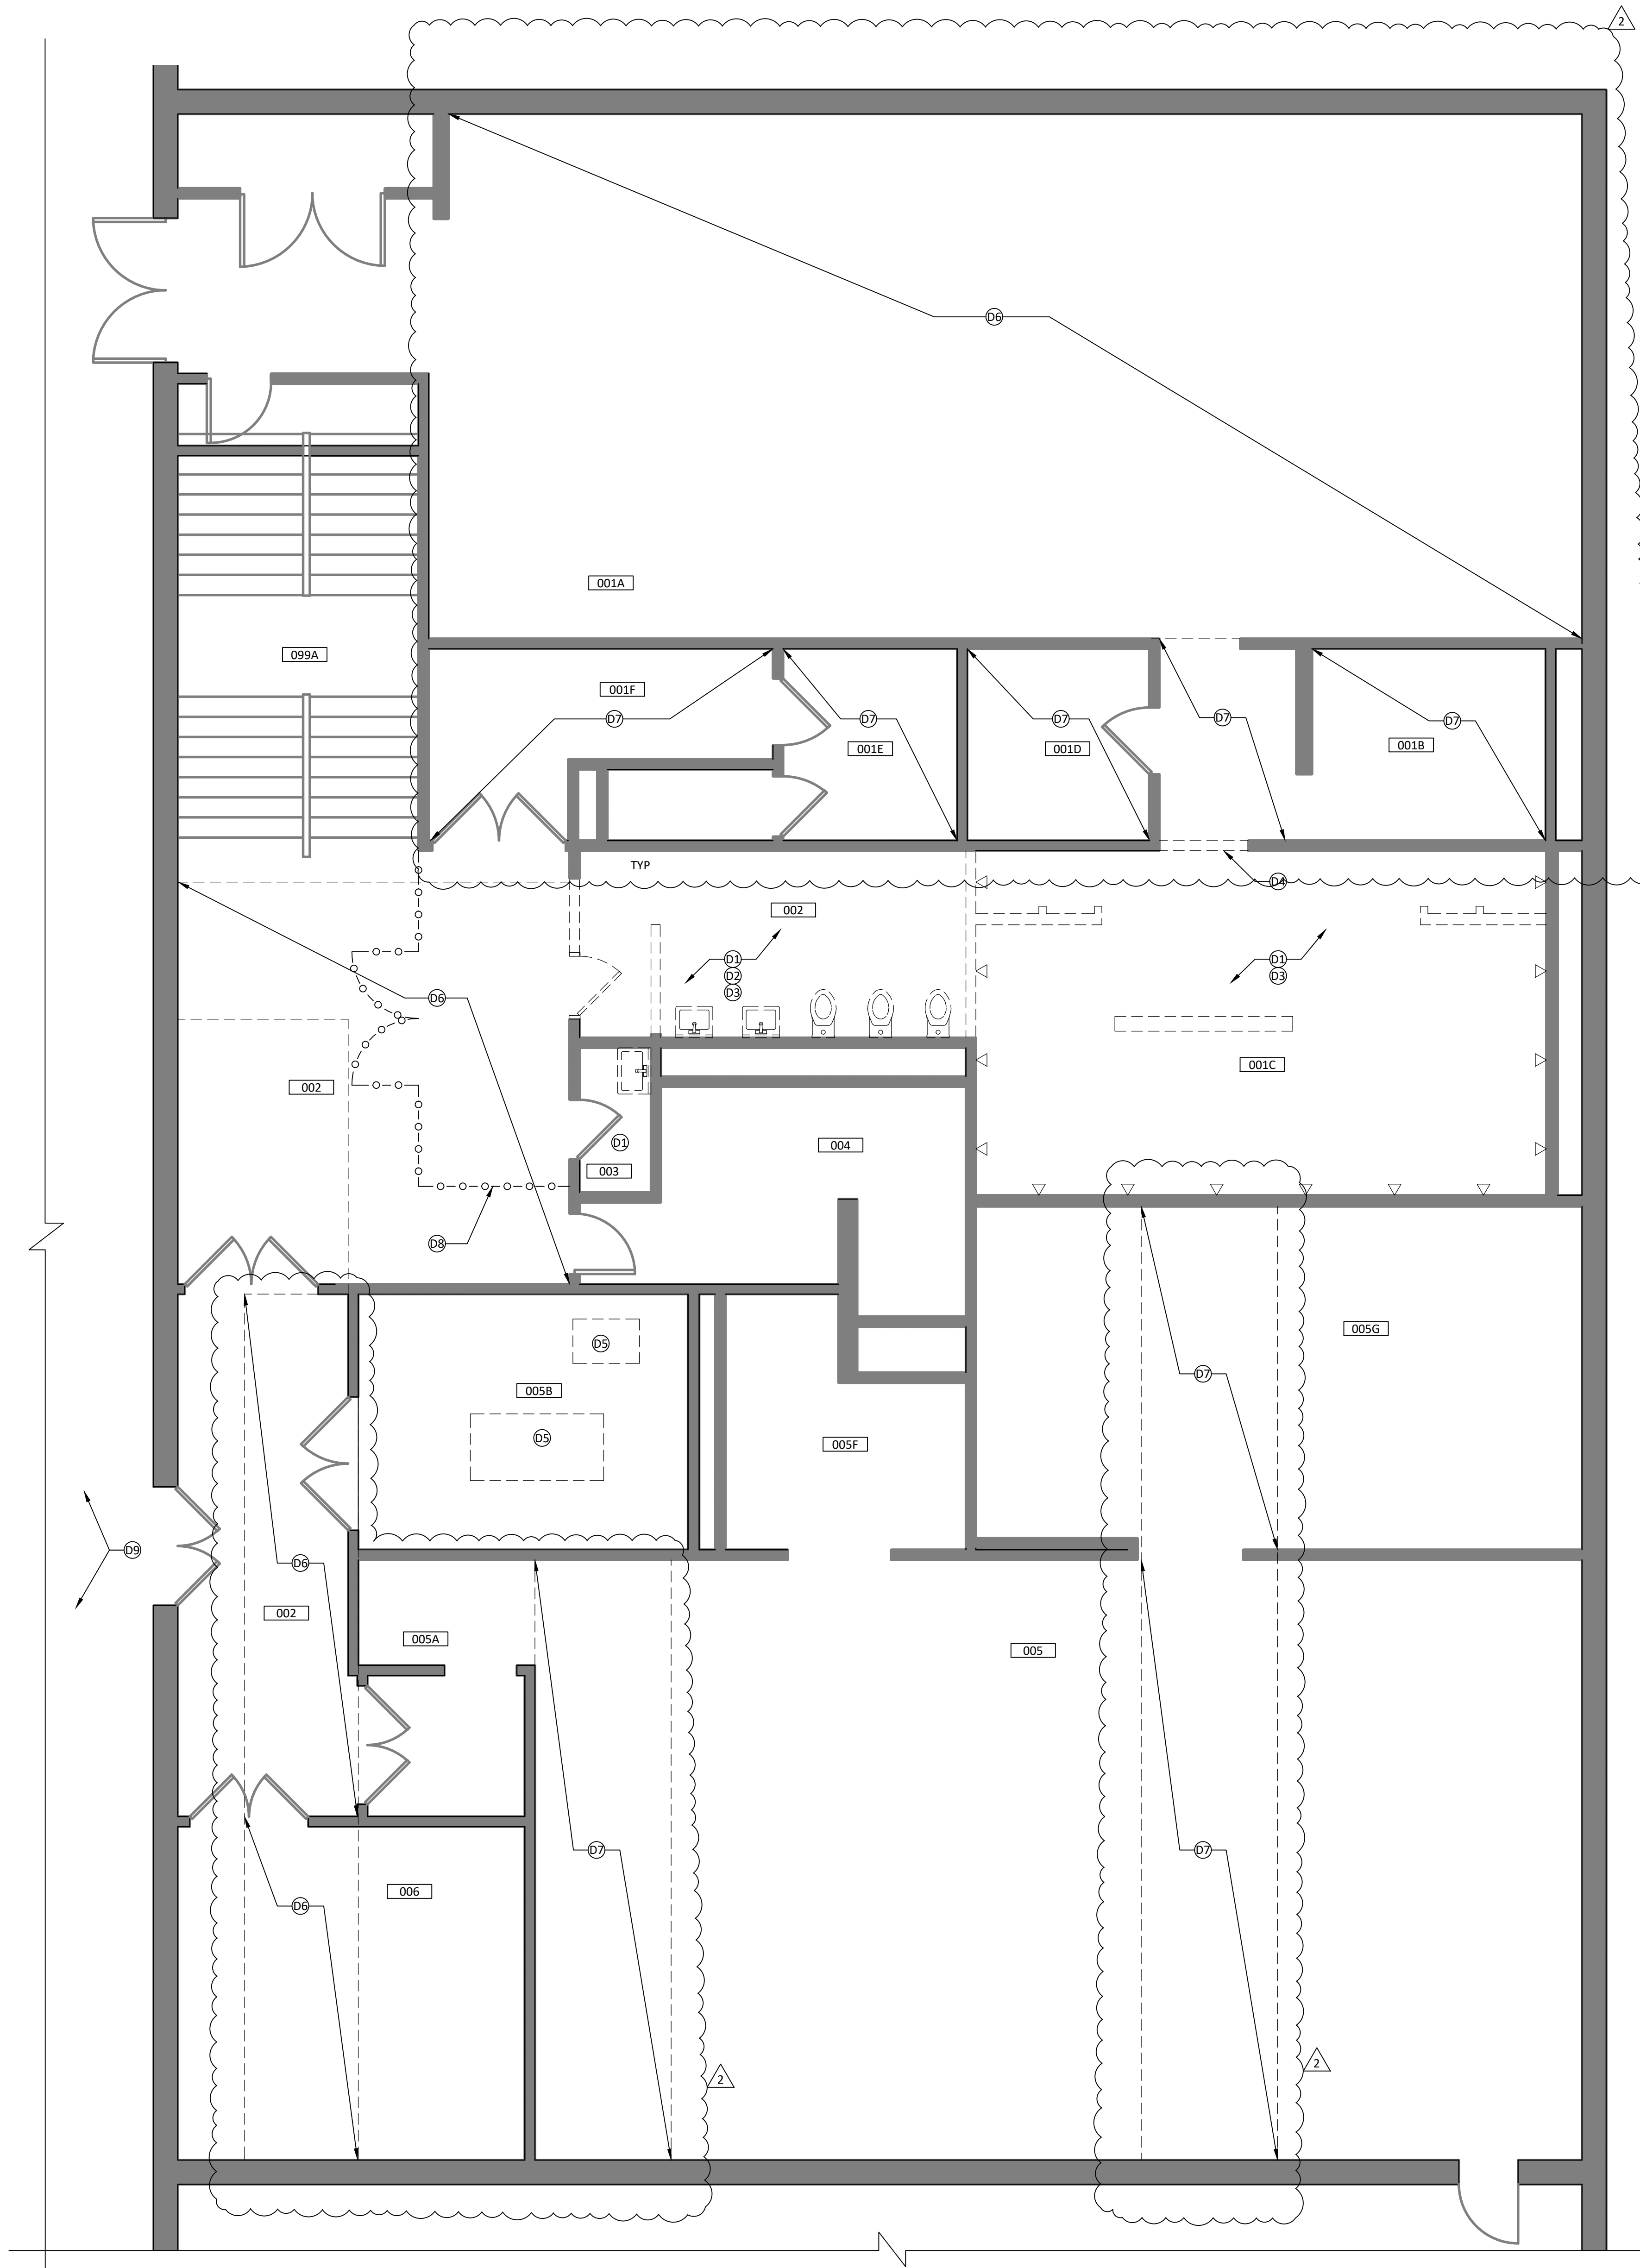

A BL572
PARTIAL LEVEL 1 DEMOLITION PLAN
SCALE: 1/4" = 1'-0"

DEMOLITION GENERAL NOTES

- GENERAL CONTRACTOR TO FIELD CHECK AND VERIFY ALL DIMENSIONS, CONDITIONS AND LOCATIONS. REPORT DISCREPANCIES TO ARCHITECT.
- COORDINATE WORK OF OTHER TRADES WITH YOUR TRADE PRIOR TO STARTING ANY CONSTRUCTION.
- PLANS ARE TO SERVE AS A GUIDE ONLY. SEE ALL CONSTRUCTION DOCUMENTS AND VISIT SITE TO DETERMINE ENTIRE SCOPE OF DEMOLITION WORK NEEDED.
- CUTTING AND PATCHING/FINISHING SHALL BE THE RESPONSIBILITY OF THE CONTRACTOR FOR WHOM THE WORK IS REQUIRED. THE ACTUAL WORK SHALL BE EXECUTED BY THE TRADE AND/OR CONTRACTOR EXPERIENCED AND SKILLED IN SUCH WORK.
- ALL SURFACES TO REMAIN THAT RECEIVE DEMOLITION WORK OR NEED PATCHING SHALL BE PATCHED AND REFINISHED AS REQUIRED TO MATCH EXISTING SURROUNDING SURFACES IN COLOR, TEXTURE, AND PATTERN TO COVER THE ENTIRE SURFACE AREA TO THE NEAREST INSIDE CORNER, OFFSET, OR INTERSECTION.
- ALL EXISTING SURFACES TO REMAIN SHALL BE PROTECTED FOR THE DURATION OF THE PROJECT WITHIN THE PROJECT LIMITS & ACCESS TO THE PROJECT.
- EXISTING WALLS ARE CMU UNLESS NOTED OTHERWISE.


DEMOLITION NOTES

- REMOVE EXISTING PLUMBING FIXTURES AND FITTING, THIS ROOM, REF P-SERIES DRAWINGS.
- REMOVE EXISTING TOILET PARTITIONS AND ACCESSORIES, THIS ROOM.
- REMOVE EXISTING PLASTER CEILING SYSTEM COMPLETE, THIS ROOM.
- REMOVE EXISTING MASONRY THRESHOLD.
- REMOVE EXISTING CONCRETE HOUSEKEEPING PADS FOR FLUSH FLOOR CONDITION.
- REMOVE AND REINSTALL EXISTING ACOUSTICAL PANEL CEILING SYSTEM AS REQUIRED FOR MEP WORK ABOVE, REFERENCE MEP SERIES DRAWINGS.
- REMOVE AND REPLACE EXISTING PLASTER CEILING SYSTEM AS REQUIRED FOR MEP WORK ABOVE, REFERENCE MEP SERIES DRAWINGS.
CONTRACTOR OPTION TO REMOVE PLASTER CEILING COMPLETE AND PROVIDE NEW SUSPENDED (1) LAYER, 5" GYPSUM BOARD CEILING SYSTEM, MATCHING THE EXISTING CEILING HEIGHT AT THIS ROOM, PAINT, AT THIS ROOM.
- PROVIDE CONSTRUCTION BARRIER AND ACCESS DOOR PER OWNER'S DIV 01 REQUIREMENTS.
- PROTECT GYM FLOOR AS REQUIRED. REFERENCE MEP SERIES FOR METHOD AND SCOPE.

LEGEND:

- EXISTING WALL
- EXISTING ITEM TO BE REMOVED
- EXISTING DOOR TO REMAIN

KEY MAP:

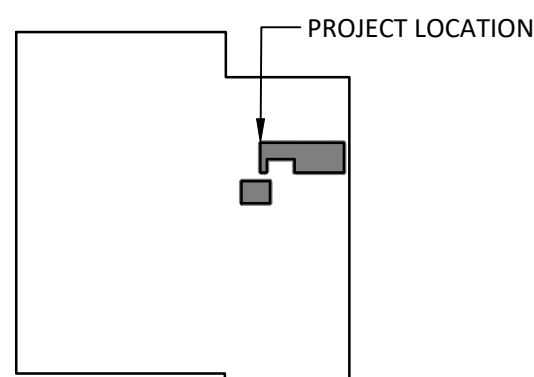

Indianapolis
8250 Haverstick Road, Suite 285
Indianapolis, IN, 46240
t: +1 800.404.7677
e: hello@introba.com
www.introba.com

Team

Introba (MEP Prime)

8250 Haverstick Road, Suite 285
Indianapolis, IN 46240
t: +1 800.404.7677
www.introba.com

Bledsoe Riggert Cooper James (Civil)

1351 West Tapp Road
Bloomington, IN 47403
t: +1 812.538.8277
www.brjcivil.com

Springpoint Architects (Architect)

522 West 2nd Street
Bloomington, IN 47403
t: +1 812.318.2930
www.springpointarchitects.com



Dawn Michelle Gwyn

NO	REVISION	CHK	DATE
2	ADDITIONAL NO. 2	DMG	10.10.2025

CLIENT
INDIANA UNIVERSITY

PROJECT ADDRESS
2721 EAST 10TH STREET
BLOOMINGTON, IN 47408

PROJECT
BL572 - INTERCOLLEGIATE ATHLETICS
GYMNASIUM - REPLACE CHILLER, HEATING
SYSTEMS, AND CONTROLS

UPLAND PROJECT #001004

DATE ISSUED

DECEMBER 19, 2025


DESIGNED: DMG CHECKED: DMG APPROVED: DMG

DRAWING STATUS
100% CONSTRUCTION DOCUMENTS

DRAWING TITLE
ARCHITECTURAL DEMOLITION PLAN, LEVEL 01
ALTERNATE BID

DRAWING NO.

D-101

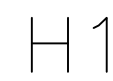

A-101

GENERAL NOTES

1. ALL STRUCTURAL WORK SHALL BE COORDINATED WITH ARCHITECTURAL AND MECHANICAL DRAWINGS AND SHALL CONFORM TO THE PROJECT SPECIFICATIONS, INCLUDING THE 2012 INTERNATIONAL BUILDING CODE AND THE 2012 INTERNATIONAL CODE OF BOAT BUILDING FOR INDIANA. THE FOLLOWING STANDARDS WERE USED AS SPECIFIED IN THE GOVERNING BUILDING CODE:
- A. ASCE 7-10 MINIMUM DESIGN LOADS (AND ASSOCIATED CRITERIA) FOR BUILDINGS AND OTHER STRUCTURES
 - B. ACI 318-11 BUILDING CODE REQUIREMENTS FOR STRUCTURAL CONCRETE
 - C. ACI 308-10 BUILDING CODE REQUIREMENTS FOR MASONRY CONSTRUCTION
 - D. ASCE 360-10 SPECIFICATION FOR STRUCTURAL STEEL BUILDINGS
2. CONTRACTOR SHALL PROVIDE TEMPORARY PROTECTIVE SHEETING AND SHALL MAKE SAFE ALL FLOORS, ROOFS, WALLS, AND ADJACENT PROPERTY AS PROJECT CONDITIONS REQUIRE. SHEETING AND SHEETINGS SHALL BE DESIGNED BY A REGISTERED PROFESSIONAL ENGINEER LICENSED IN THE STATE OF INDIANA. THE CONTRACTOR SHALL SUBMIT SHOP DRAWINGS AND CALCULATIONS FOR THE OWNER'S REVIEW.
3. DIMENSIONS AND ELEVATIONS OF EXISTING CONSTRUCTION GIVEN IN STRUCTURAL DRAWINGS ARE TO BE INFORMED BY THE INFORMATION PROVIDED IN THE CONTRACT DOCUMENTS. THE CONTRACTOR SHALL VERIFY ALL INFORMATION PERTAINING TO EXISTING CONDITIONS BY ACTUAL MEASUREMENT AND RECORD. THE CONTRACTOR SHALL REPORT ALL EXISTING CONDITIONS AND THOSE SHOWN IN THE CONTRACT DOCUMENTS SHALL BE REPORTED TO THE ENGINEER OF RECORD FOR EVALUATION BEFORE THE AFFECTED CONSTRUCTION IS PUT IN PLACE.
4. CONTRACT DOCUMENTS AND SPECIFICATIONS SHALL BE USED TO HIGHLIGHT DISCREPANCIES RATHER THAN REPLACE THE SPECIFICATIONS CONTAINED IN THE PROJECT MANUAL.

SPECIAL INSPECTIONS

- | | | |
|---|--|---|
| A. | INSPECTIONS REQUIRED BY THE LOCAL JURISDICTION SHALL BE PERFORMED BY A TESTING AGENCY PROVIDED BY THE OWNER FOR THE FOLLOWING ITEMS: | |
| | a. | INSPECTION OF FABRICATORS (IBC 1704.2.5) |
| | b. | STEEL CONSTRUCTION (IBC 1705.2.1) <ul style="list-style-type: none"> • STRUCTURAL STEEL (IBC 1705.2.1) • WELDINGS (IBC 1705.2.2) • STRUCTURAL STEEL (ASCE 360, AWS D1.1) • HIGH STRENGTH BOLTS (AISC 360) |
| | c. | CONCRETE CONSTRUCTION (IBC 1705.4.3 TABLE 1705.3) |
| | d. | POST-INSTALLED ANCHORS (IBC TABLE 1705.3) |
| B. | MASONRY CONSTRUCTION (IBC 1705.4.3 AND 530 AND ASCE 530 1 LABEL B QUALITY ASSURANCE) | |
| | STRUCTURAL OBSERVATIONS REQUIRED BY THE LOCAL JURISDICTION AND IBC 1704.5 SHALL BE PERFORMED BY THE TESTING AGENCY. ADDITIONAL PROVIDED BY THE OWNER. STRUCTURAL OBSERVATIONS SHALL BE THE VISUAL OBSERVATION OF THE STRUCTURAL SYSTEM FOR GENERAL CONFORMANCE TO THE APPROVED CONSTRUCTION DOCUMENTS. | |
| A TESTING AGENCY THAT PERFORMS THE INSPECTIONS SHALL FILE ALL APPROPRIATE FORMS WITH THE BUILDING DEPARTMENT. | | |

SHEET KEYNOTES

1. W8x15 (TYP-4) T/STEEL 0'-8". ALIGN BEAMS WITH WEB/TOP CHORD INTERSECTIONS OF JOISTS BELOW. MOST NORTERN BEAM TO BE PAINTED OSHA APPROVED YELLOW.
2. W4x13 (TYP-8) T/STEEL 0'-8". COORDINATE LOCATIONS WITH BOILER BASE FRAME.
3. TS8x2x1/4 AS REQUIRED FOR GRATING SUPPORT AT FREE EDGES.
4. 19-W-4 GRATING WITH 1-1/4x3/16 BARS. GRATING TO BE PAINTED OSHA APPROVED YELLOW.



INDIANA UNIVERSITY
BLOOMINGTON, INDIANA



Indianapolis
8250 Haverstick Road, Suite 285
Indianapolis, IN, 46240

t: +1 800.404.7677
e: hello@introba.com
www.introba.com

Team

Introba (MEP Prime

8250 Haverstick Road, Suite 285
Indianapolis, IN 46240
t: +1 800.404.7677
www.introba.com

Bledsoe Riggert Cooper James (Civil

1351 West Tapp Road
Bloomington, IN 47403
t: +1 812.336.8277
www.brcjcivil.com

Springpoint Architects (Architect)

522 West 2nd Street
Bloomington, IN 47403
t: +1 812.318.2930
www.springpointarchitects.com



NO	REVISION	CHK	DATE

INDIANA UNIVERSITY

PROJECT ADDRESS
2721 EAST 10TH STREET
BLOOMINGTON, IN 47408

PROJECT
BL572 - INTERCOLLEGIATE ATHLETICS
GYMNASIUM - REPLACE CHILLER, HEATING
SYSTEMS, AND CONTROLS

IJ PROJECT #20240613
INTOCBA PROJECT #001264

DATE ISSUED
DECEMBER 19, 2022


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100% CONSTRUCTION DOCUMENTS

DRAWING TITLE
STRUCTURAL PLAN BL572 LEVEL 2 BASE BID

DRAWING M

S-101

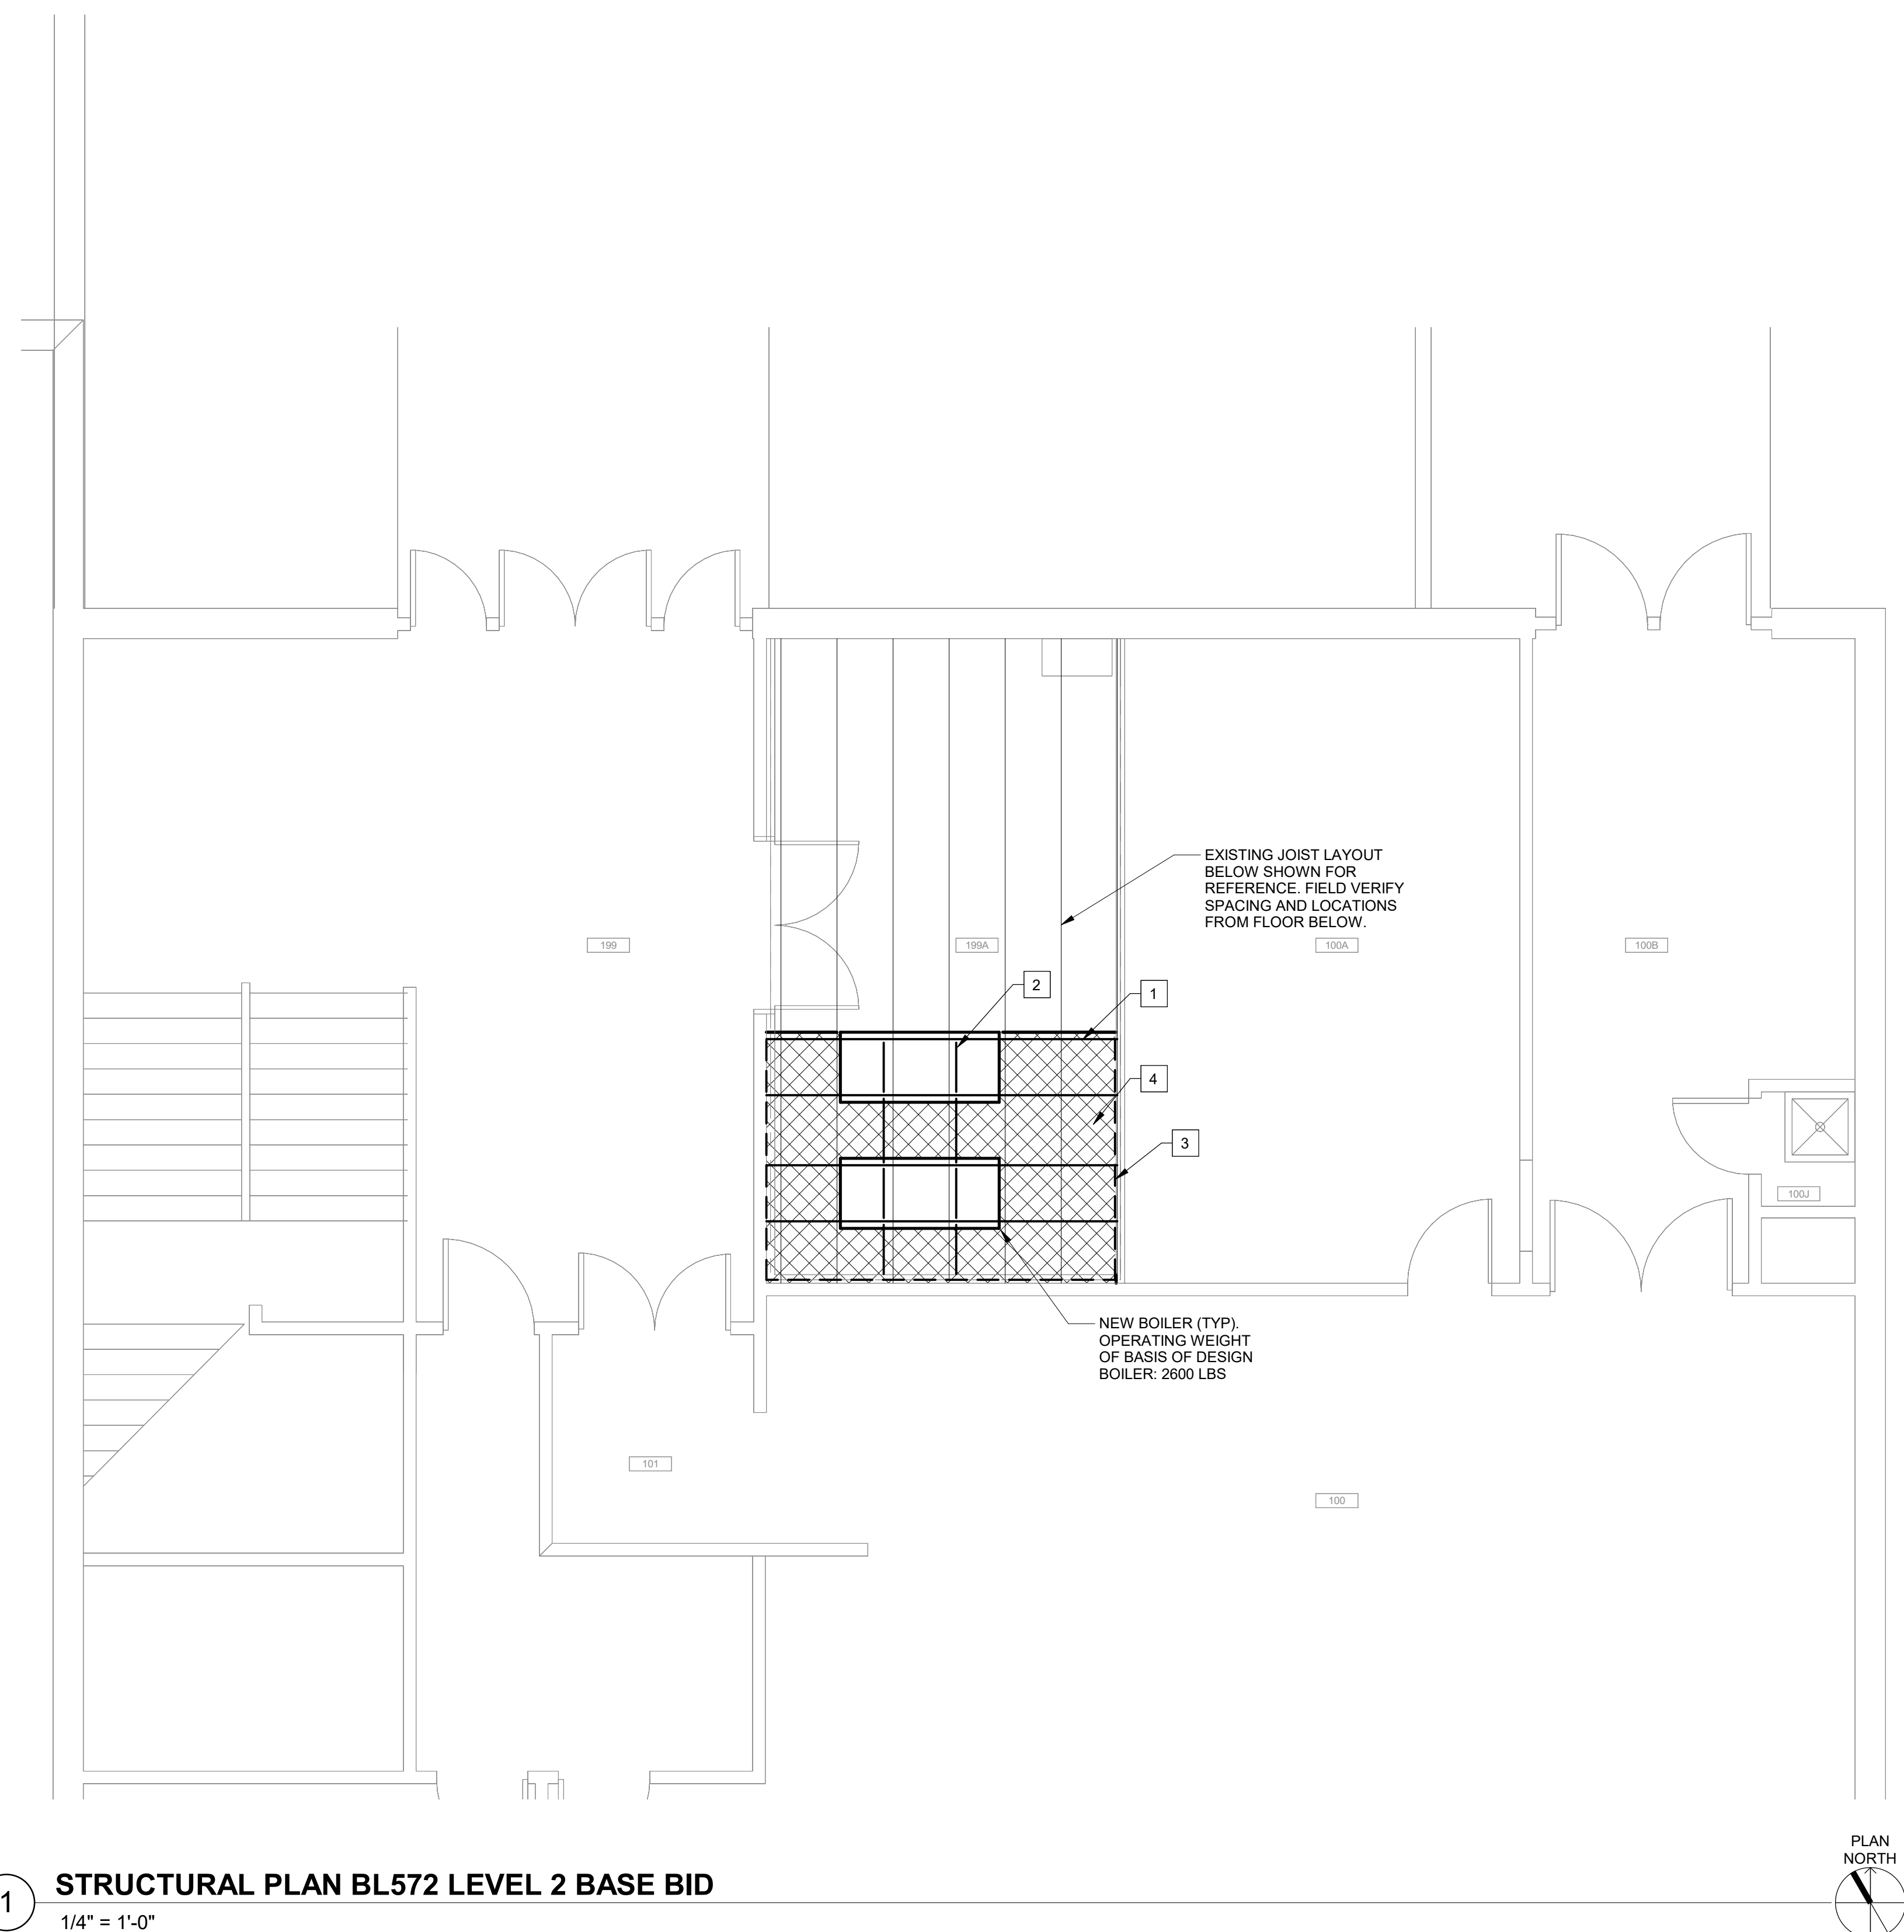

1

STRUCTURAL PLAN BL572 LEVEL 2 BASE BID

$$1/4" = 1'-0"$$

PLAN



1 PLUMBING DEMOLITION PLAN BL571 LEVEL 1 (ALTERNATE #4)
1/8" = 1'-0"


SHEET KEYNOTES

1.

A. **BASE BID:** EXISTING DOMESTIC TANK-TYPE WATER HEATER, INCLUDING HOT WATER RECIRCULATION PUMP AND ALL VALVING AND PIPING, TO REMAIN ACTIVE IN GNOC BUILDING AS IS TO SERVE THE IGYM HOT WATER LOAD. NO DEMOLITION REQUIRED.

B. **ALTERNATE #4:** EXISTING DOMESTIC TANK-TYPE WATER HEATER TO BE DISCONNECTED FROM ALL PIPING AND ACCESSORIES IN GNOC AND TRANSPORTED TO IGYM FOR REUSE AND RECONNECTION. EXISTING HOT WATER RECIRCULATION PUMP, PIPING, VALVING, AND OTHER WATER HEATING ACCESSORIES FOR DOMESTIC WATER GOING TO IGYM BUILDING TO BE DEMOLISHED. PIPING TO BE DEMOLISHED BACK TO THE NEAREST MAIN AND CAPPED. PIPING GOING THROUGH EXTERIOR WALL TO BE CAPPED AT THE WALL PENETRATION AND ABANDONED.

a. NOTE: IGYM BUILDING IS TO BE ACTIVE AND OCCUPIED DURING CONSTRUCTION. DISCONNECTION AND TRANSPORTING OF THE WATER HEATER TO IGYM AND DEMOLITION OF PIPING AND RELATED ACCESSORIES SHALL BE DELAYED UNTIL NEW WATER HEATING EQUIPMENT AND PIPING IS COMPLETELY INSTALLED IN IGYM AND READY FOR TIE-IN TO MINIMIZE SHUT-DOWN AS MUCH AS POSSIBLE. COORDINATE SHUT-DOWN WITH OTHER TRADES AND OWNER PRIOR TO CONSTRUCTION.

Introba

Indianapolis
8250 Haverstick Road, Suite 285
Indianapolis, IN 46240
t: +1 800.404.7677
e: hello@introba.com
www.introba.com

Ten:
Introba (MEP Prime)

8250 Haverstick Road, Suite 285
Indianapolis, IN 46240
t: +1 800.404.7677
www.introba.com

Bledsoe Riggert Cooper James (Civil)

1351 West Tapp Road
Bloomington, IN 47403
t: +1 812.338.8277
www.brojcivil.com

Springpoint Architects (Architect)

522 West 2nd Street
Bloomington, IN 47403
t: +1 812.318.2930
www.springpointarchitects.com

2	ADDENDUM 2		01/23/26
NO	REVISION	CHK	DATE
CLIENT: INDIANA UNIVERSITY			
PROJECT ADDRESS: 2721 EAST 10TH STREET BLOOMINGTON, IN 47408			
PROJECT: BL572 - INTERCOLLEGIATE ATHLETICS GYMNASIUM - REPLACE CHILLER, HEATING SYSTEMS, AND CONTROLS			
U:\PROJECTS\2026\13 INTROBA PROJECT #01004			
DATE ISSUED: DECEMBER 19, 2025			
DESIGNED RJH	CHECKED Checker	APPROVED Approver	
DRAWING STATUS 100% CONSTRUCTION DOCUMENTS			
DRAWING TITLE PLUMBING DEMOLITION PLAN BL571 LEVEL 1			
DRAWING NO. PD-200			

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Introba (MEP Prime)

8250 Haverstick Road, Suite 285
Indianapolis, IN 46240
t: +1 800.404.7677
www.introba.com

Bledsoe Riggert Cooper James (Civil)

1351 West Tapp Road
Bloomington, IN 47403
t: +1 812.336.8277
www.brcicivill.com

Springpoint Architects (Architect)

522 West 2nd Street
Bloomington, IN 47403
t: +1 812.318.2930
www.springpointarchitects.com



2	ADDENDUM 2		01/23/20
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CLIENT
INDIANA UNIVERSITY

PROJECT ADDRESS
2721 EAST 10TH STREET
BLOOMINGTON, IN 47408

PROJECT
BL572 - INTERCOLLEGIATE ATHLETICS
GYMNASIUM - REPLACE CHILLER, HEATING
SYSTEMS, AND CONTROLS

IJ PROJECT #20240613
INTROCA PROJECT #001204

DATE ISSUED
DECEMBER 19, 2025


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100% CONSTRUCTION DOCUMENTS

DRAWING TITLE
PLUMBING DEMOLITION PLAN BL572 LEVEL 1
UNDERFLOOR

DRAWING M

PD-201

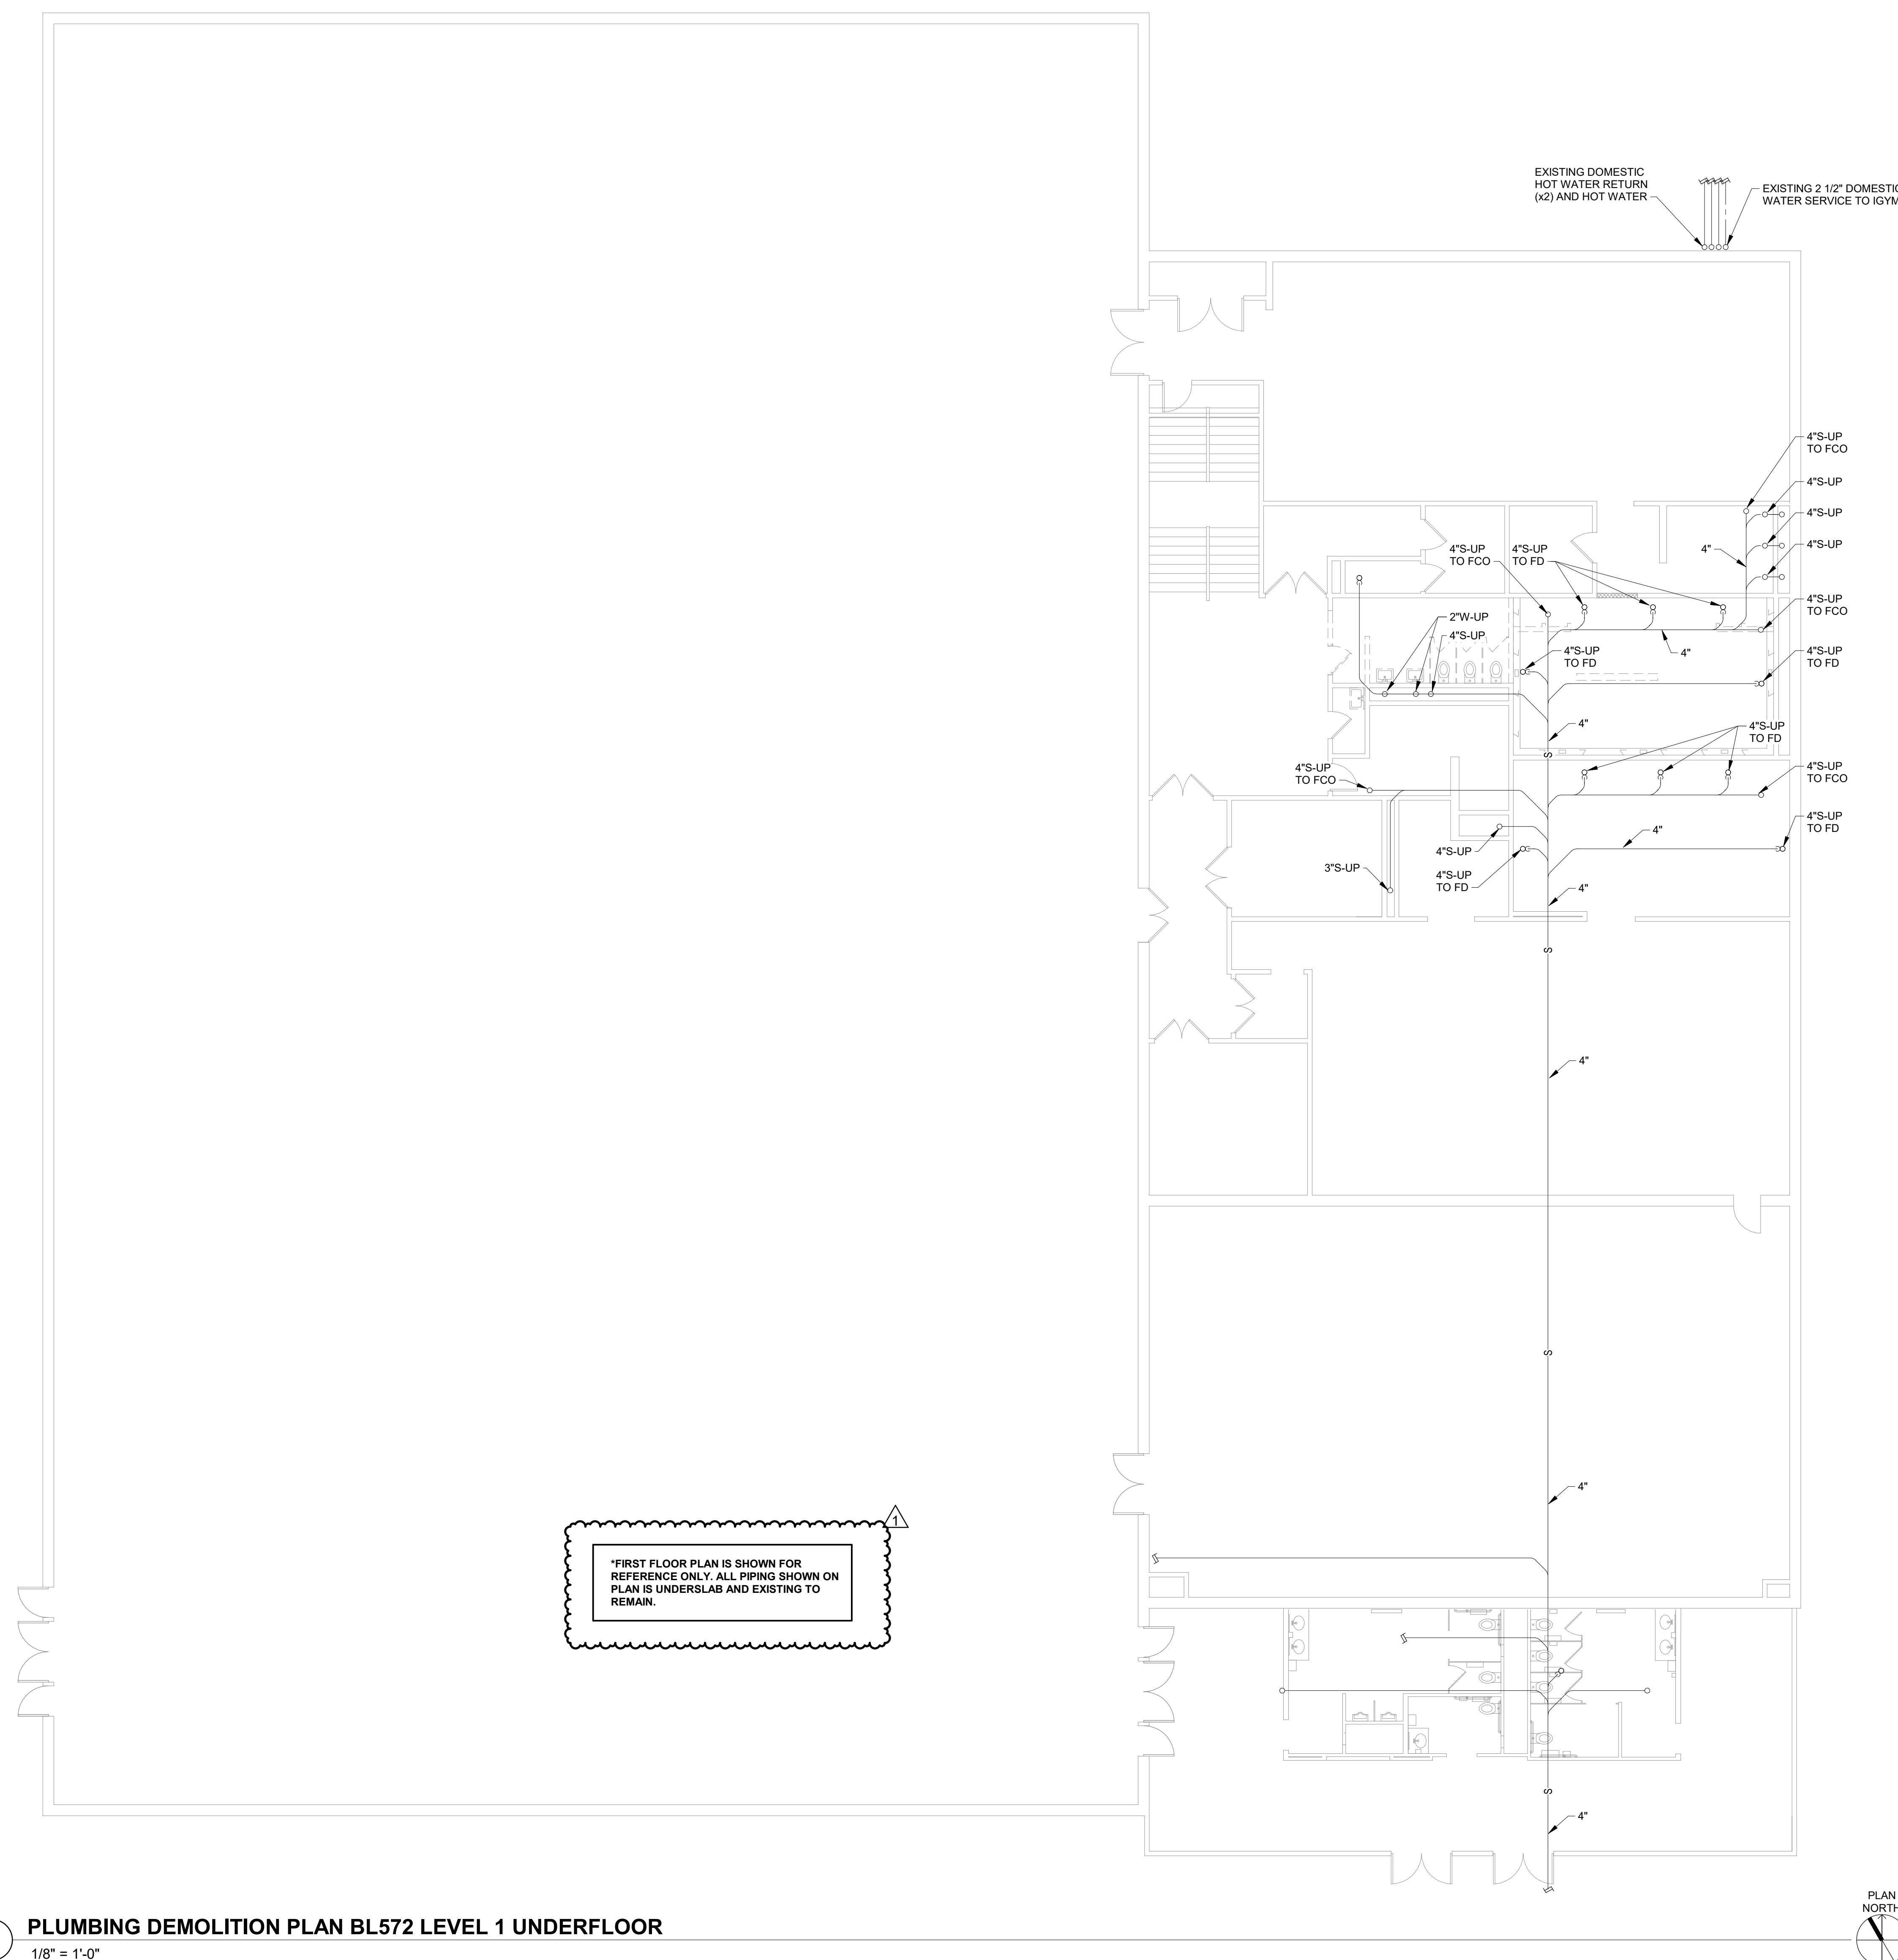


1 PLUMBING DEMOLITION PLAN BL572 LEVEL 1 UNDERFLOOR

1/8" = 1'-0"



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- # SHEET KEYNOTES**
1. ALTERNATE #4 EXISTING FLOOR DRAIN TO BE DEMOLISHED AND CLEANOUT COVER TO EXISTING PIPE FLOOR PENETRATION AND REWORK FLOOR SLAB AND FLOORING AS NEEDED.
 2. ALTERNATE #4 EXISTING PLUMBING FIXTURE TO BE DEMOLISHED. ASSOCIATED WATER SUPPLY PIPING TO BE DEMOLISHED AND CAPPED AT THE NEAREST WALL. WALL TO BE PATCHED IN NEW WORK PHASE TO MATCH NEW FINISHES.
 3. ALTERNATE #4 EXISTING SHOWER HEADS TO BE DEMOLISHED. PIPING TO BE CAPPED AT THE WALL. WALL TO BE PATCHED IN NEW WORK TO MATCH NEW FINISHES.
 4. ALTERNATE #4 DEMOLISH PIPING BACK TO THIS POINT.
 5. ALTERNATE #4 DEMOLISH DOMESTIC HOT WATER AND HOT WATER RETURN TO THE WALL AND CAP. ABANDON OUTSIDE UNDERGROUND PIPING IN PLACE. COLD WATER TO REMAIN ACTIVE AND RECONNECTED IN NEW WORK PHASE. PROVIDE TEMPORARY CONNECTIONS AS REQUIRED TO MAINTAIN OCCUPANCY WITH LIMITED OUTAGES, AS BUILDING WILL BE ACTIVE DURING CONSTRUCTION.
 6. ALTERNATE #4 EXISTING PLUMBING FIXTURE TO BE DEMOLISHED. ASSOCIATED WATER SUPPLY, WASTE AND VENT PIPING TO BE DEMOLISHED BACK TO NEAREST MAIN AND CAPPED.
 7. EXISTING 2ND FLOOR JANITORS SINK TO BE DEMOLISHED. EXISTING ROUGH-IN PIPING TO REMAIN FOR CONNECTION TO NEW FLOOR MOP BASIN IN NEW WORK PHASE.

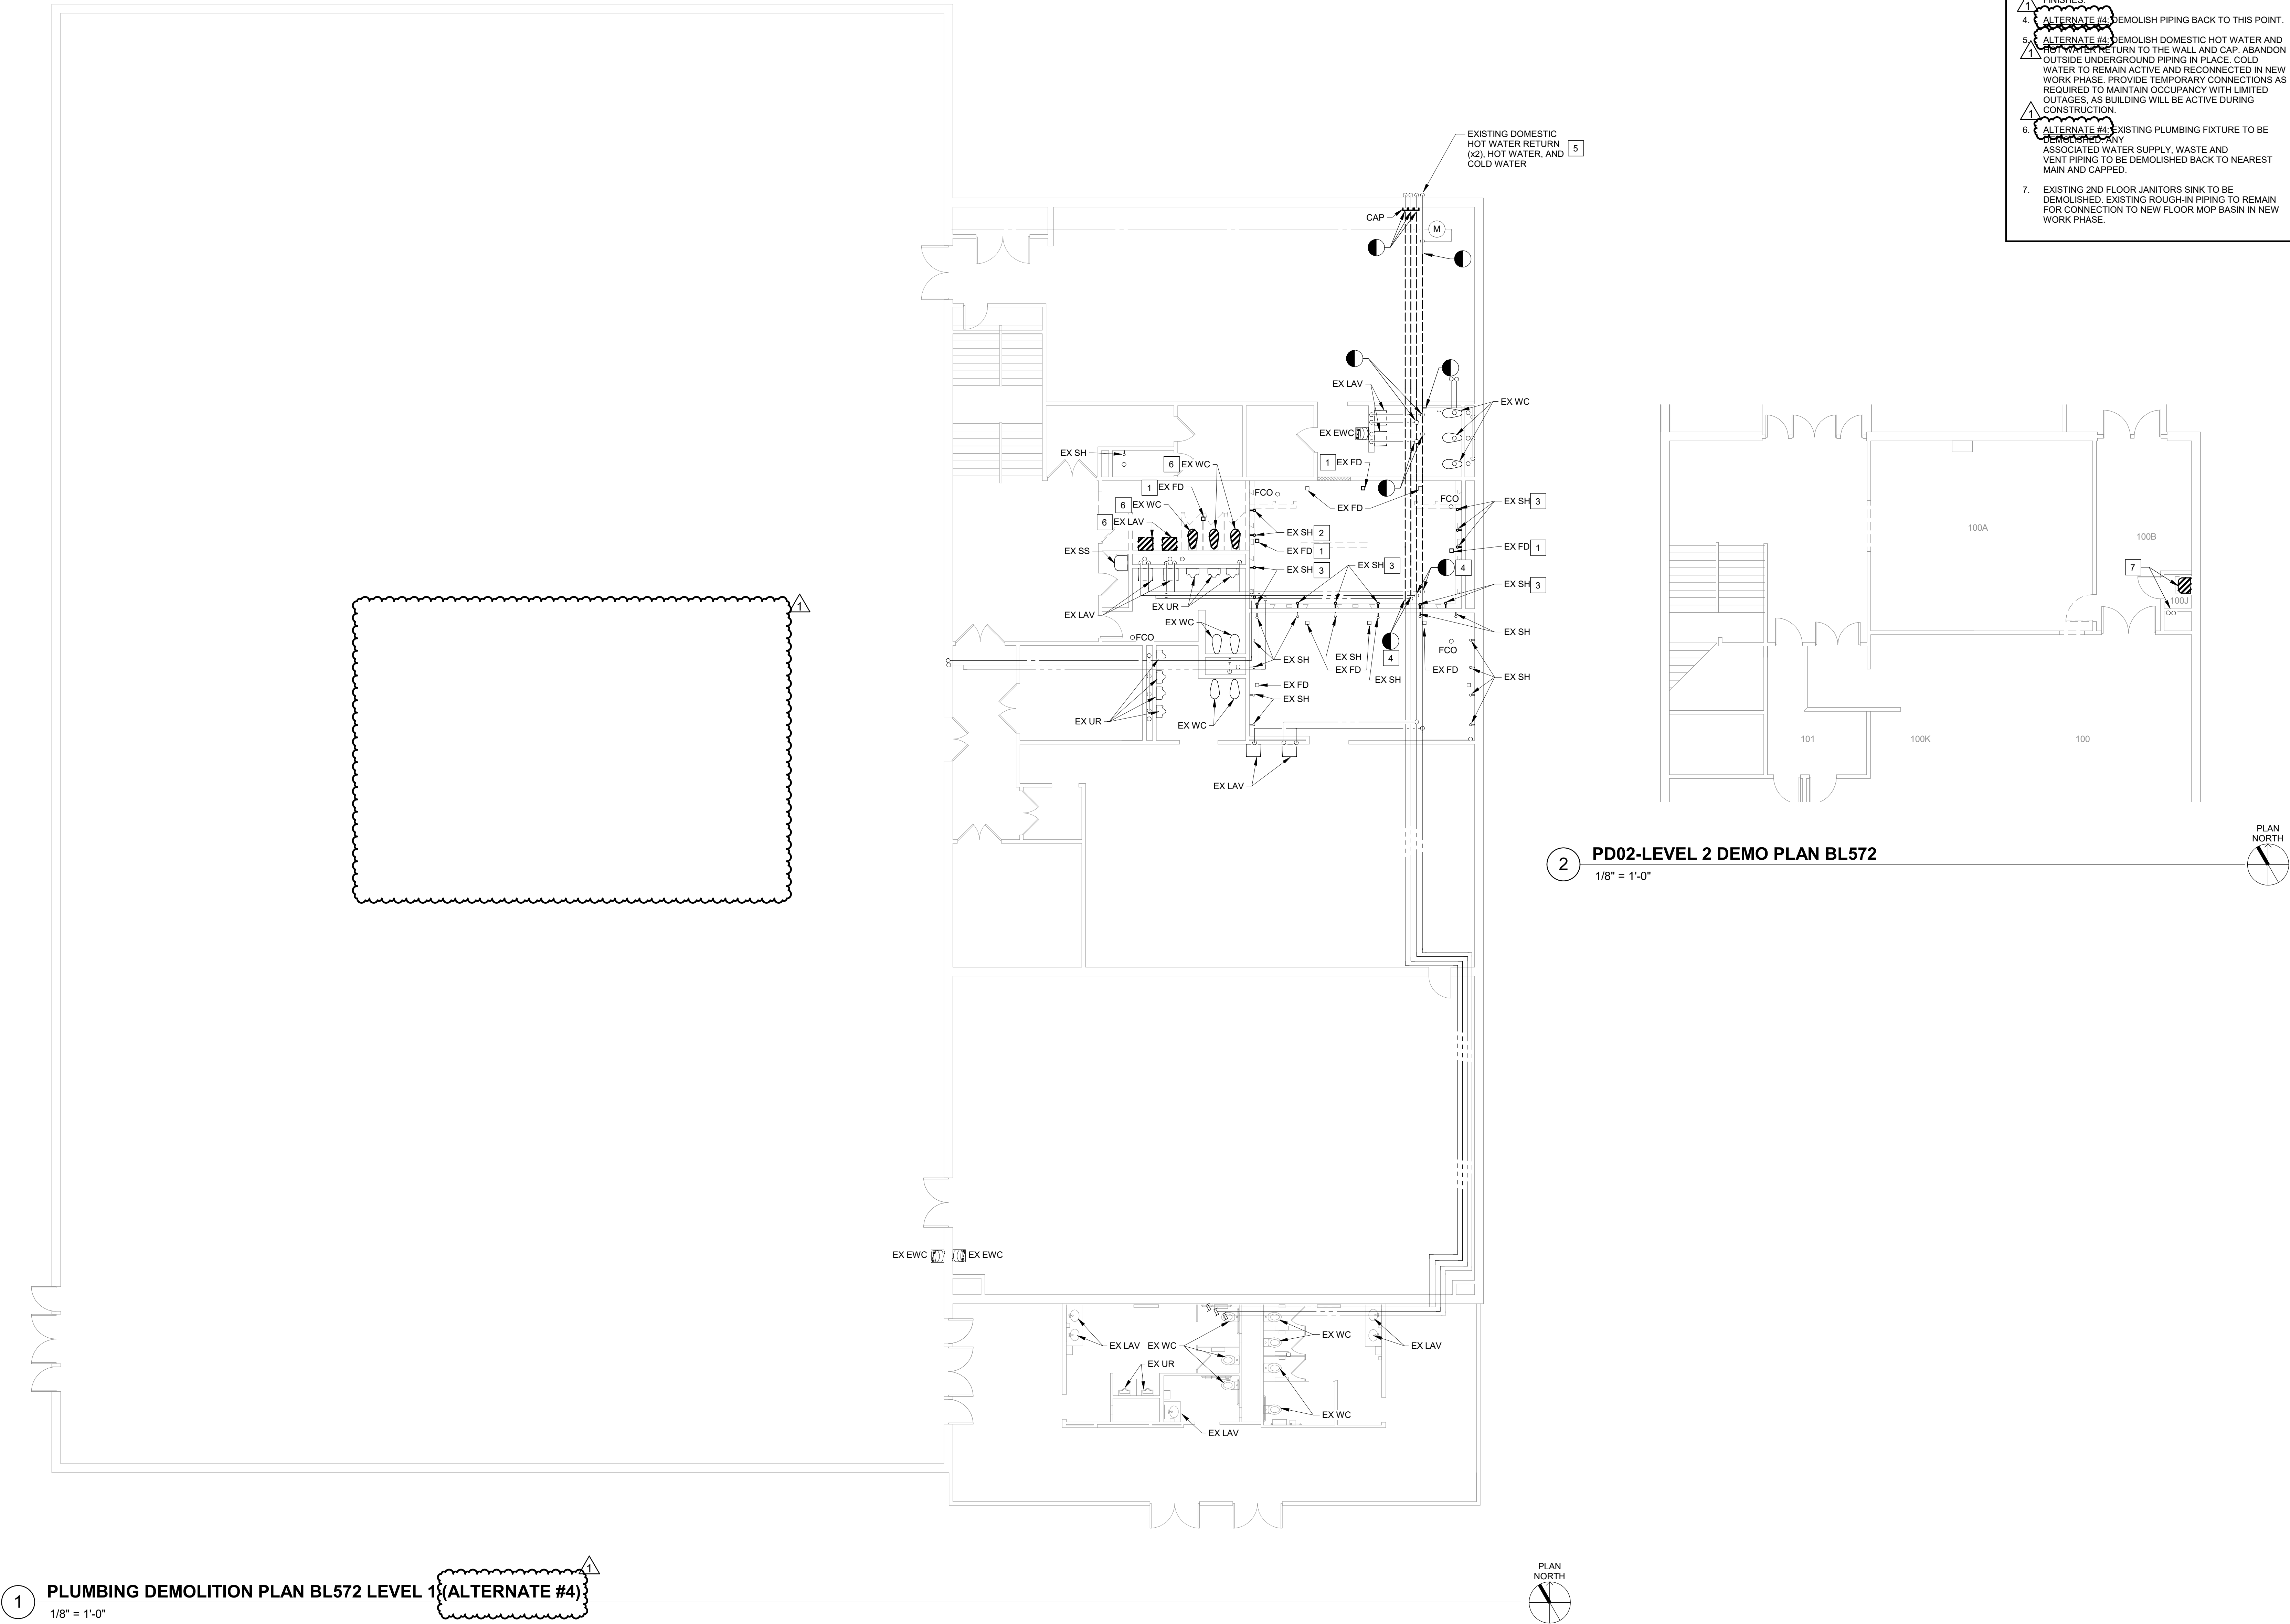

INDIANA UNIVERSITY
BLOOMINGTON, INDIANA



Indianapolis
8250 Haverstick Road, Suite 285
Indianapolis, IN 46240
t: +1 800.404.7677
e: hello@introba.com
www.introba.com

Team

Introba (MEP Prime)

8250 Haverstick Road, Suite 285
Indianapolis, IN 46240
t: +1 800.404.7677
www.introba.com

Bledsoe Riggert Cooper James (Civil)

1351 West Tapp Road
Bloomington, IN 47403
t: +1 812.338.8277
www.brojcivil.com

Springpoint Architects (Architect)

522 West 2nd Street
Bloomington, IN 47403
t: +1 812.318.2930
www.springpointarchitects.com



2	ADDENDUM 2		01/23/26
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CLIENT
INDIANA UNIVERSITY

PROJECT ADDRESS
2721 EAST 10TH STREET
BLOOMINGTON, IN 47408

PROJECT
BL572 - INTERCOLLEGIATE ATHLETICS
GYMNASIUM - REPLACE CHILLER, HEATING
SYSTEMS, AND CONTROLS

PROJECT NUMBER
INTROBA PROJECT #000004

DATE ISSUED
DECEMBER 19, 2025

DESIGNED RJH	CHECKED Checker	APPROVED Approver
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100% CONSTRUCTION DOCUMENTS

DRAWING TITLE
PLUMBING DEMOLITION PLAN BL572 LEVEL 1
& 2

DRAWING NO.

PD-202



GENERAL NOTES

- A. THE CONTRACTOR SHALL COMPLETE A DYE TEST TO ENSURE THAT THE PROPOSED CONNECTION PIPE IS IN FACT SANITARY AND NOT STORM. ADDITIONALLY, THE CONTRACTOR SHALL COMPLETE A CAMERA INSPECTION AND LOCATE TO ENSURE THAT THE PIPE IS IN GOOD WORKING CONDITION. REPORT ANY ISSUES TO THE OWNER/ARCHITECT. NO REPAIRS SHALL BE MADE WITHOUT THE CONSENT AND SIGN-OFF BY THE OWNER. CONTRACTOR TO COORDINATE THIS WORK WITH IU CONSTRUCTION MANAGER AND UTILITIES. REFER TO FLOOR PLAN FOR SCOPE OF DYE TESTING AND CAMERA WORK.

SHEET KEYNOTES

1. SAWCUT EXISTING CONCRETE SLAB FOR INSTALLATION OF NEW SANITARY/WASTE PIPING SERVING NEW FUTURE. PATCH CONCRETE AND FLOOR TO MATCH EXISTING SURROUNDING SURFACES. COORDINATE NEW UNDER-SLAB SANITARY/WASTE PIPING WITH EXISTING STRUCTURAL COMPONENTS.
2. THIS SAWCUTTING AND PIPING WORK IS TO BE PERFORMED UNDER ALTERNATE#4. BASE BID, THIS WORK NOT REQUIRED.
3. THIS SAWCUTTING AND PIPING WORK IS TO BE PERFORMED UNDER BASE BID. UNDER ALTERNATE #4, THIS WORK NOT REQUIRED.



INDIANA UNIVERSITY
BLOOMINGTON, INDIANA



Indianapolis
8250 Haverstick Road, Suite 285
Indianapolis, IN, 46240
t: +1 800.404.7677
e: hello@introba.com
www.introba.com

Team

Introba (MEP Prime)

8250 Haverstick Road, Suite 285
Indianapolis, IN 46240
t: +1 800.404.7677
www.introba.com

Bledsoe Riggert Cooper James (Civil)

1351 West Tapp Road
Bloomington, IN 47403
t: +1 812.336.8277
www.brcicivil.com

Springpoint Architects (Architect)

522 West 2nd Street
Bloomington, IN 47403
t: +1 812.318.2930
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2	ADDENDUM 2		01/23/26
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2721 EAST 10TH STREET
BLOOMINGTON, IN 47408

PROJECT
BL572 - INTERCOLLEGIATE ATHLETICS
GYMNASIUM - REPLACE CHILLER, HEATING
SYSTEMS, AND CONTROLS

IU PROJECT #20240613
INTRODUA PROJECT #001306

DATE ISSUED
DECEMBER 19, 2025

DESIGNED PJH	CHECKED Checker	APPROVED Asorover
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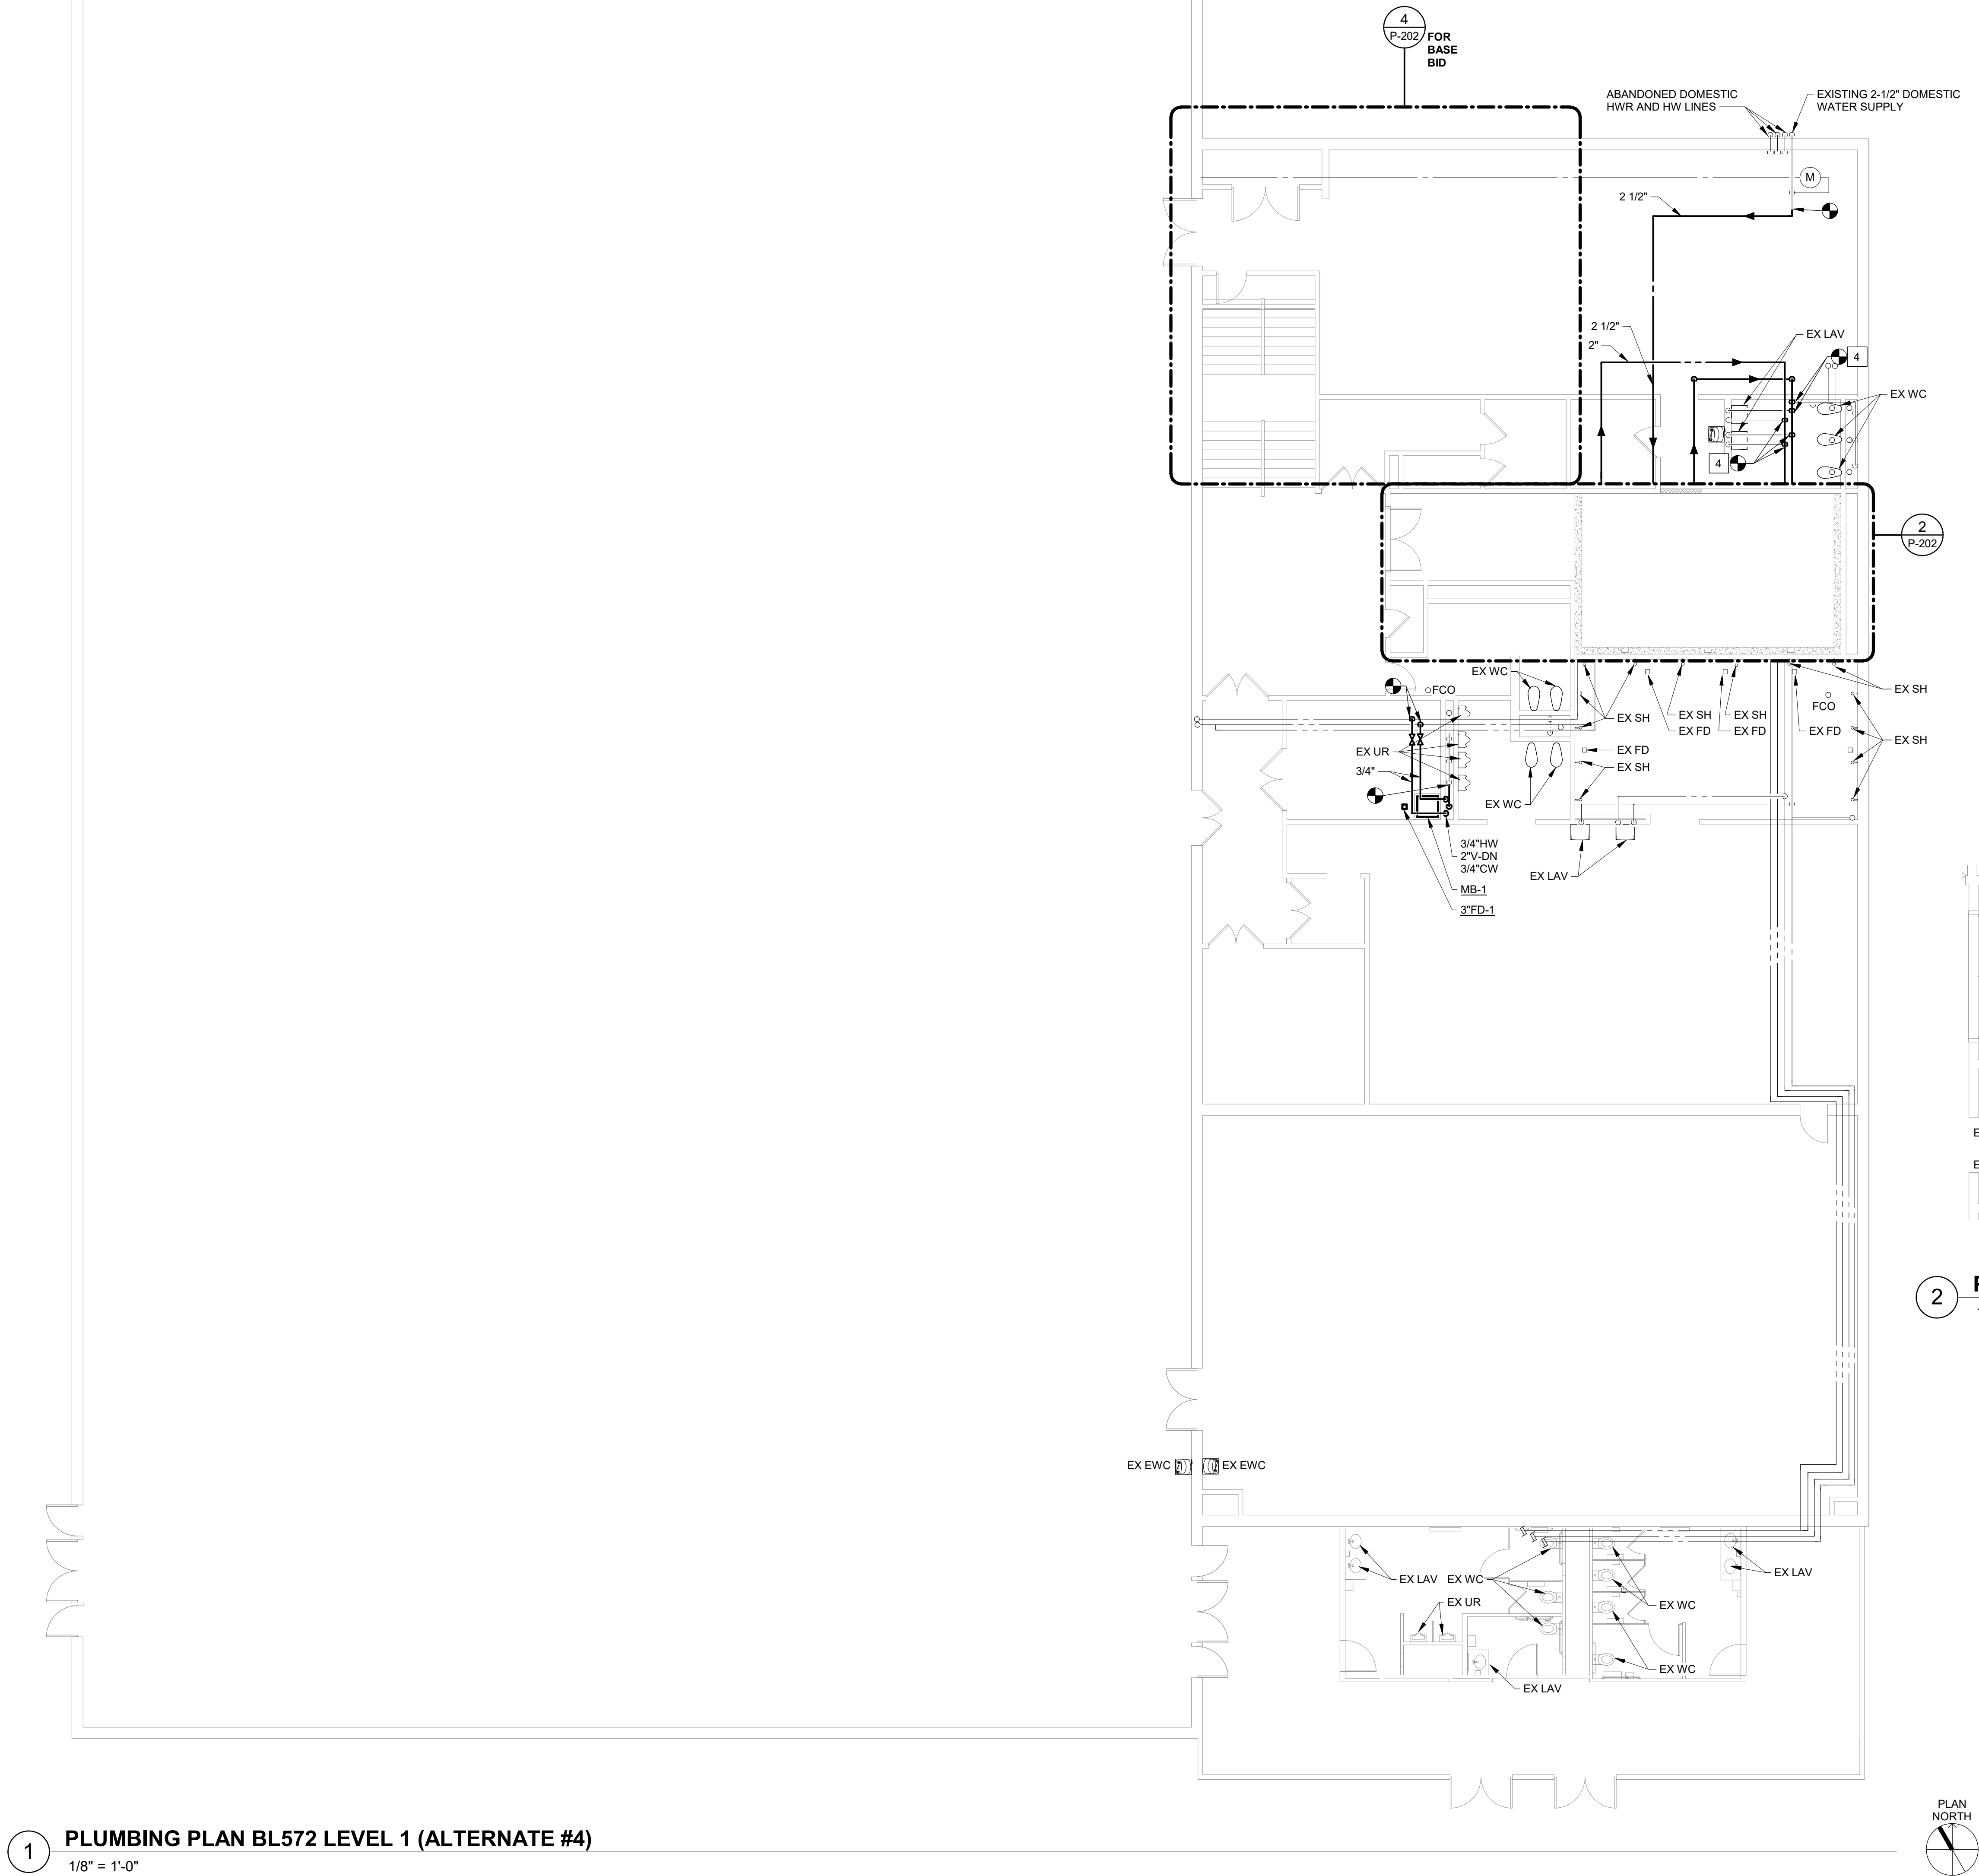
100% CONSTRUCTION DOCUMENTS

DRAWING TITLE
PLUMBING PLAN BL572 LEVEL 1
UNDERFLOOR

DRAWING NO:


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1 PLUMBING PLAN BL572 LEVEL 1 (ALTERNATE #4)
1/8" = 1'-0"

3 PD02-LEVEL 2 PLAN BL572 (BASE BID)
1/8" = 1'-0"



2 PLUMBING - LEVEL 1 PLAN BL572 - NEW MECH ROOM ENLARGED PLAN (ALT #4)
1/4" = 1'-0"

4 PLUMBING PLAN BL572 LEVEL 1 (BASE BID)
1/8" = 1'-0"

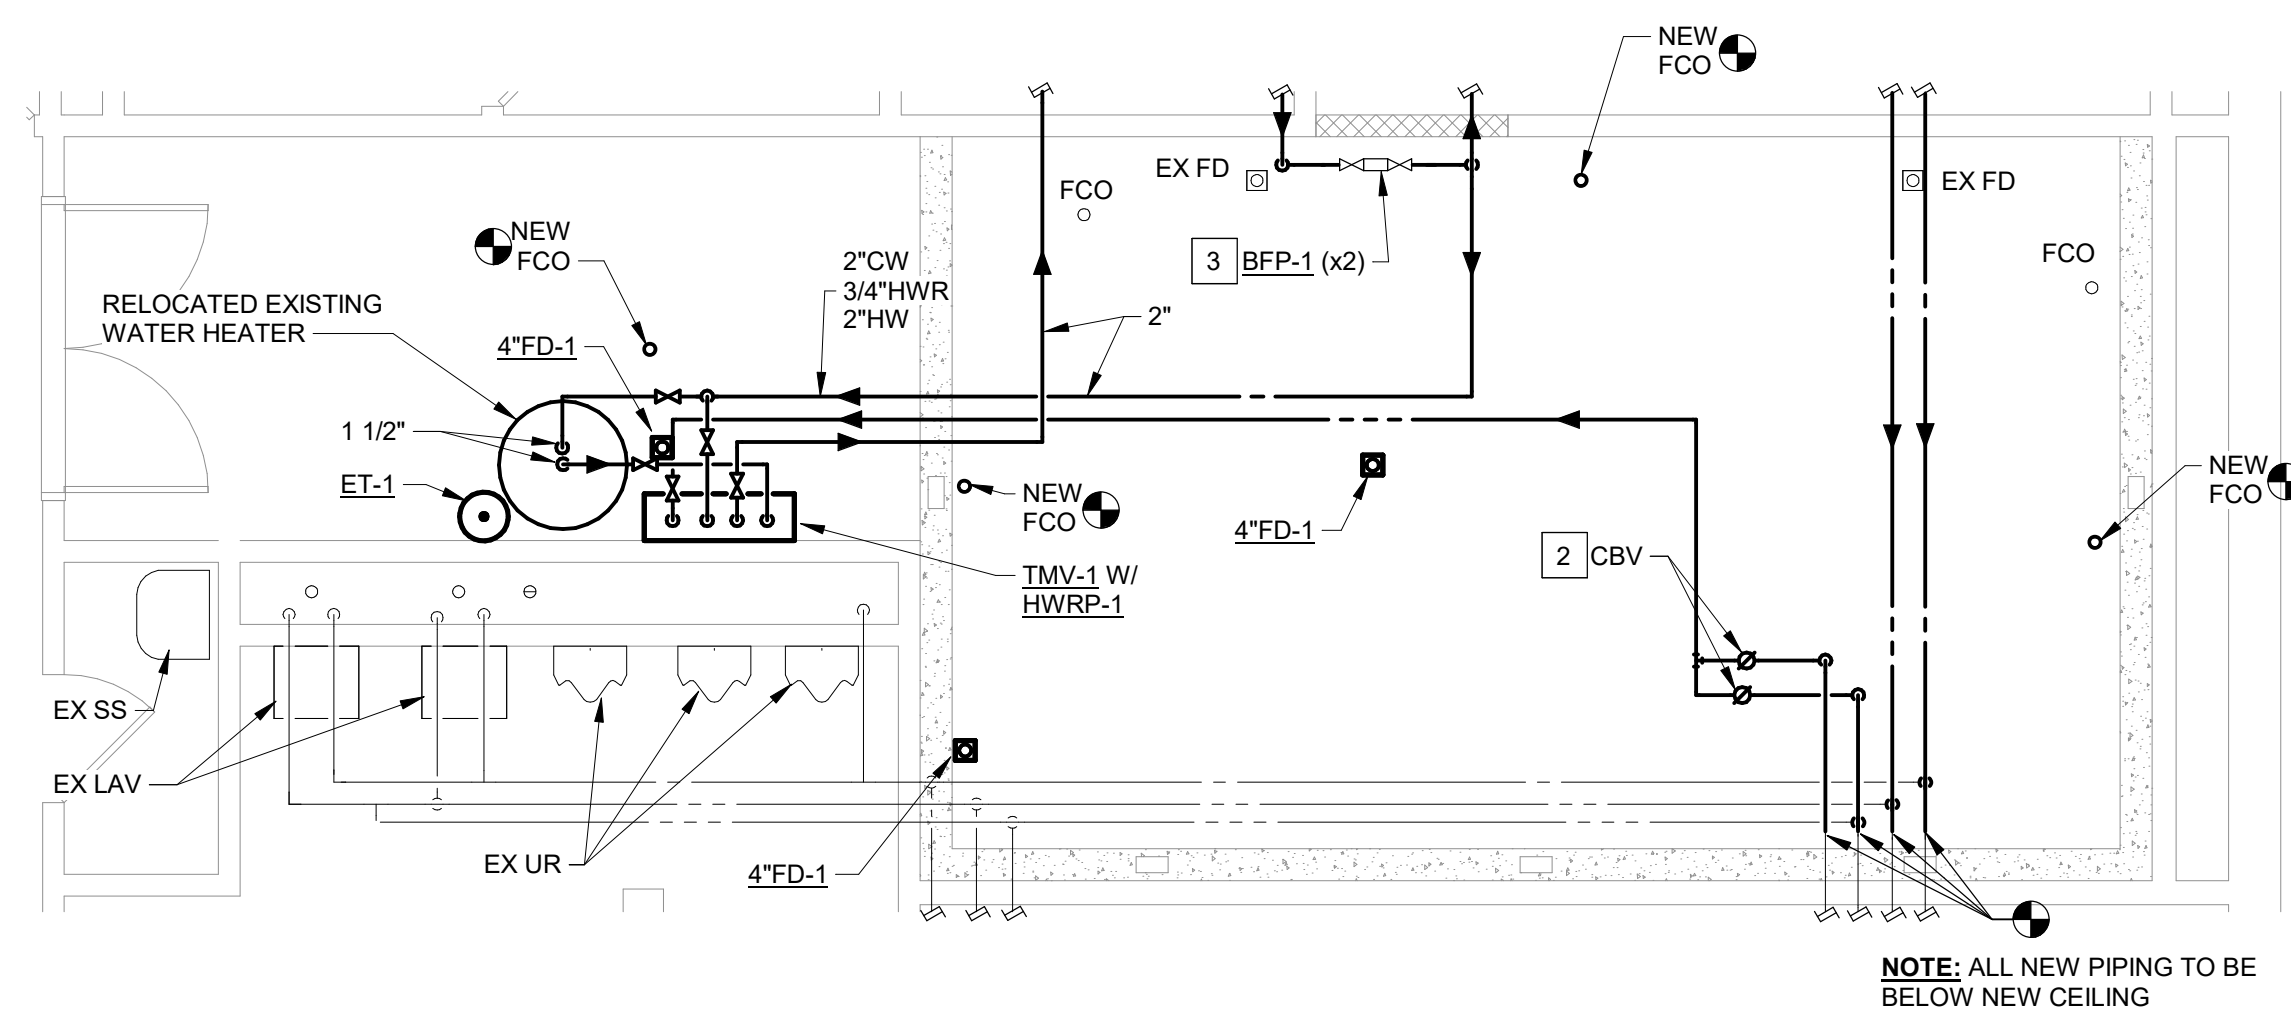- | # | SHEET KEYNOTES |
|----|--|
| 1. | NOT USED. |
| 2. | ALTERNATE #4: CALIBRATED BALANCING VALVE (CBV-1) ARRANGEMENT: SEE "CALIBRATED BALANCING VALVE" DETAIL ON SHEET P-600. |
| 3. | ALTERNATE #4: TWO NEW STACKED 2-1/2" DOMESTIC WATER BACKFLOW PREVENTERS, BFP-1. |
| 4. | ALTERNATE #4: RECONNECT EXISTING FIXTURE SUPPLY PIPING TO NEW DOMESTIC C/W/HW WATER MAINS. |
| 5. | NEW MOP BASIN MB-1 TO BE INSTALLED IN PLACE OF PREVIOUS JANITORS SINK UTILIZING EXISTING ROUGH-IN. SOME WATER AND WASTE PIPING MAY NEED TO BE REWORKED AND A CORE DRILL FOR THE DRAIN TRAP WILL BE REQUIRED. |
| 6. | BASE BID: INSTALL 3"W PIPING FOR 2ND FLOOR FLOOR DRAINS IN BOILER ROOM. THIS PIPING WORK IS TO BE PERFORMED UNDER BASE BID. UNDER ALTERNATE #4, THIS WORK NOT REQUIRED. |
| 7. | BASE BID: INSTALL FLOOR DRAIN IN 2ND FLOOR FLOOR BOILER ROOM. THIS WORK IS TO BE PERFORMED UNDER BASE BID. UNDER ALTERNATE #4, THIS WORK NOT REQUIRED. COORDINATE FLOOR DRAIN LOCATIONS WITH MECHANICAL EQUIPMENT. |



Introba
Indianapolis
8250 Haverstick Road, Suite 285
Indianapolis, IN, 46240
t: +1 800.404.7677
e: hello@introba.com
www.introba.com

Team

Introba (MEP Prime)

8250 Haverstick Road, Suite 285
Indianapolis, IN 46240
t: +1 800-404-7677
www.introba.com

Bledsoe Riggert Cooper James (Civil)

1351 West Tapp Road
Bloomington, IN 47403
t: +1 812-338-8277
www.brojcivil.com

Springpoint Architects (Architect)

522 West 2nd Street
Bloomington, IN 47403
t: +1 812.318.2930
www.springpointarchitects.com



2	ADDENDUM 2		01/23/26
NO	REVISION	CHK	DATE

CLIENT
INDIANA UNIVERSITY

PROJECT ADDRESS
2721 EAST 10TH STREET
BLOOMINGTON, IN 47408

PROJECT
BL572 - INTERCOLLEGIATE ATHLETICS
GYMNASIUM - REPLACE CHILLER, HEATING
SYSTEMS, AND CONTROLS

U PROJECT #20250306

INTROBA PROJECT #010004

DATE ISSUED
DECEMBER 19, 2025

DESIGNED	RJM	CHECKED	Checker	APPROVED	Approver
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100% CONSTRUCTION DOCUMENTS

DRAWING TITLE
PLUMBING PLAN BL572 LEVEL 1 & 2

P-202

